


three inches = one foot
one and one half inches = one foot
one inch = one foot
three quarters inch = one foot
one half inch = one foot
three eighths inch = one foot
one quarter inch = one foot
one eighth inch = one foot

A
B
C
D
E
F

Revisions
Date

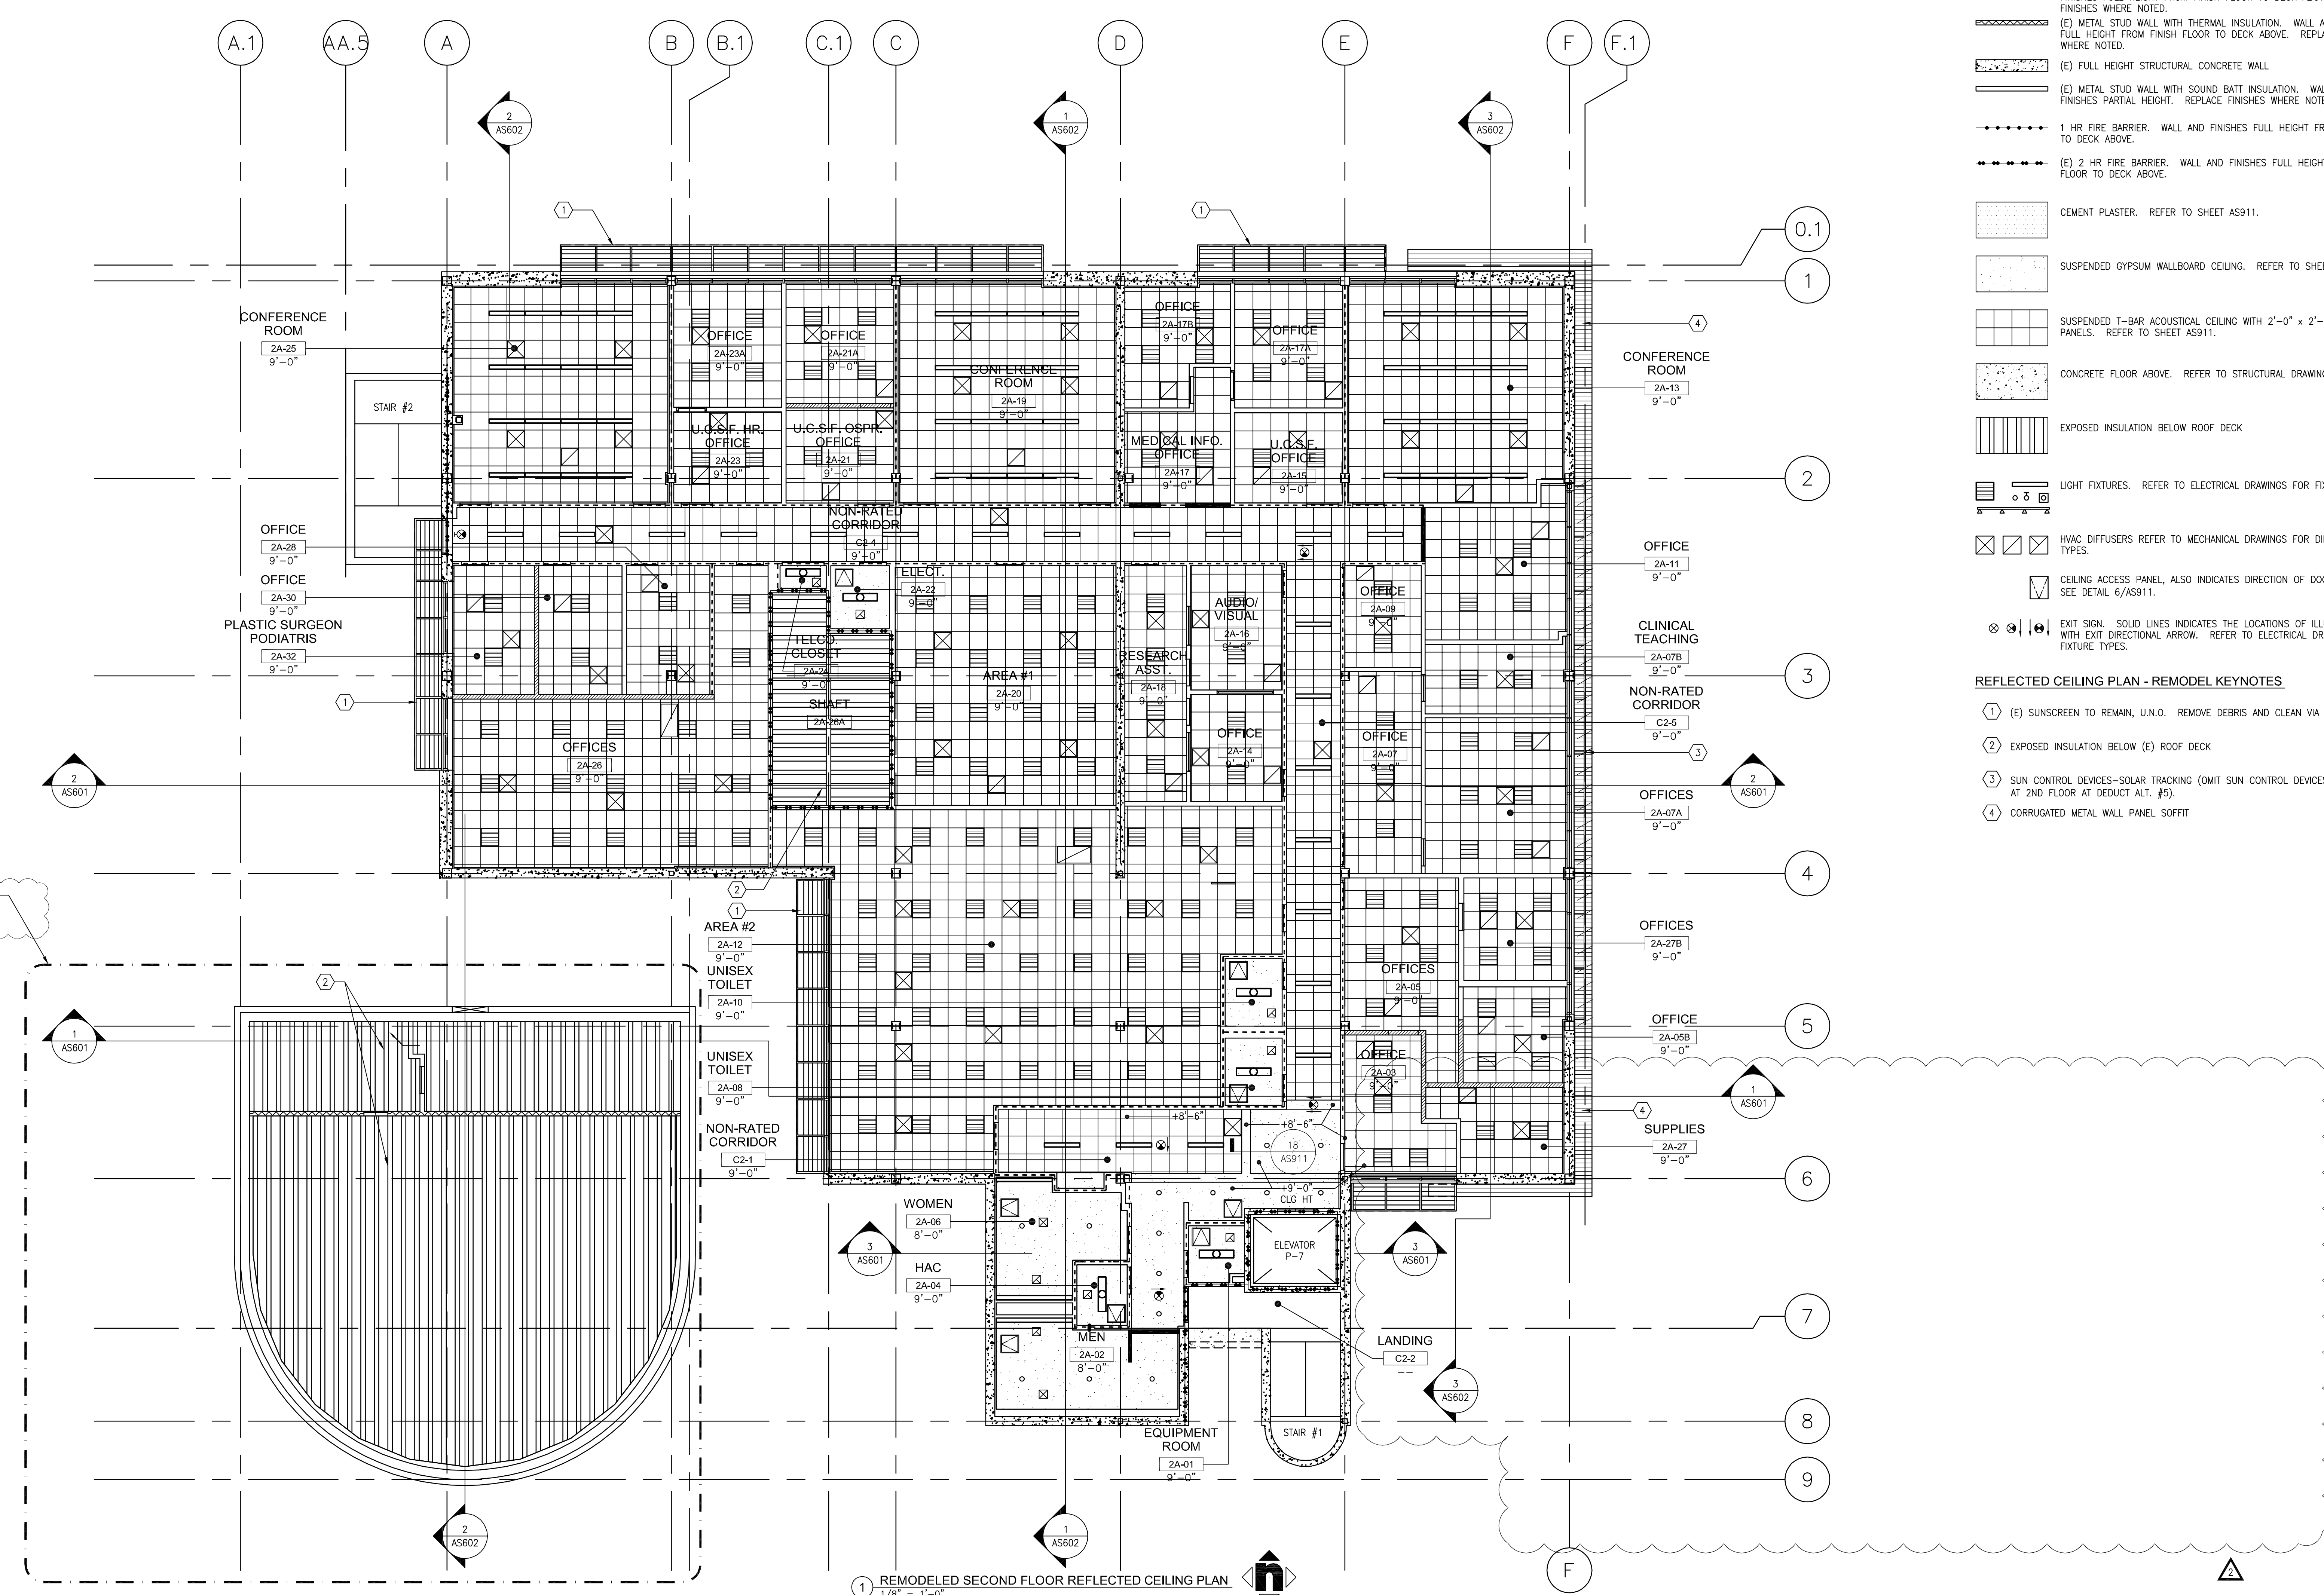

- REFLECTED CEILING PLAN LEGEND**
- FULL HEIGHT METAL STUD @ 16" O.C. U.N.O. WITH SOUND BATT. INSULATION AND FINISHES FULL HEIGHT FROM FINISH FLOOR TO DECK ABOVE. REFER TO DETAIL 6, 7 & 8/AS906.
 - PARTIAL HEIGHT METAL STUD @ 16" O.C. U.N.O. WITH SOUND BATT. INSULATION AND FINISHES FROM FINISH FLOOR TO 2" ABOVE FINISH CEILING. REFER TO DETAIL 5/AS906.
 - (E) METAL STUD WALL WITH SOUND BATT INSULATION. WALL AND FINISHES FULL HEIGHT FROM FINISH FLOOR TO DECK ABOVE. REPLACE FINISHES WHERE NOTED.
 - (E) METAL STUD WALL WITH THERMAL INSULATION. WALL AND FINISHES FULL HEIGHT FROM FINISH FLOOR TO DECK ABOVE. REPLACE FINISHES WHERE NOTED.
 - (E) FULL HEIGHT STRUCTURAL CONCRETE WALL.
 - (E) METAL STUD WALL WITH SOUND BATT INSULATION. WALL AND FINISHES PARTIAL HEIGHT. REPLACE FINISHES WHERE NOTED.
 - 1 HR FIRE BARRIER. WALL AND FINISHES FULL HEIGHT FROM FLOOR TO DECK ABOVE.
 - (E) 2 HR FIRE BARRIER. WALL AND FINISHES FULL HEIGHT FROM FLOOR TO DECK ABOVE.
 - CEMENT PLASTER. REFER TO SHEET AS911.
 - SUSPENDED GYPSUM WALLBOARD CEILING. REFER TO SHEET AS911.
 - SUSPENDED T-BAR ACOUSTICAL CEILING WITH 2'-0" x 2'-0" INFILL PANELS. REFER TO SHEET AS911.
 - CONCRETE FLOOR ABOVE. REFER TO STRUCTURAL DRAWINGS.
 - EXPOSED INSULATION BELOW ROOF DECK.
 - LIGHT FIXTURES. REFER TO ELECTRICAL DRAWINGS FOR FIXTURE TYPES.
 - HVAC DIFFUSERS REFER TO MECHANICAL DRAWINGS FOR DIFFUSER TYPES.
 - CEILING ACCESS PANEL, ALSO INDICATES DIRECTION OF DOOR SWING. SEE DETAIL 6/AS911.
 - EXIT SIGN - SOLID LINES INDICATES THE LOCATIONS OF ILLUMINATION WITH EXIT DIRECTIONAL ARROW. REFER TO ELECTRICAL DRAWINGS FOR FIXTURE TYPES.
- REFLECTED CEILING PLAN - REMODEL KEYNOTES**
- (1) (E) SUNSCREEN TO REMAIN, U.N.O. REMOVE DEBRIS AND CLEAN VIA POWERWASH.
 - (2) EXPOSED INSULATION BELOW (E) ROOF DECK.
 - (3) SUN CONTROL DEVICES-SOLAR TRACKING (OMIT SUN CONTROL DEVICES AT 2ND FLOOR AT DEDUCT ALT. #5).
 - (4) CORRUGATED METAL WALL PANEL SOFFIT

1 REMODELED SECOND FLOOR REFLECTED CEILING PLAN
1/8" = 1'-0"

<p>07/22/13 07/25/13</p>		<p>CONSULTANTS:</p>		<p>ARCHITECT/ENGINEERS:</p>		<p>Drawing Title SECOND FLOOR REFLECTED CEILING PLAN</p>		<p>Project Title BUILDING 24 SEISMIC CORRECTION AND ADDITION</p>		<p>Project Number 570-215 Building Number 24</p>		<p>Office of Construction and Facilities Management</p>	
				<p>HMC Architects 1827 E. Fir Avenue, Studio 103 / Fresno, CA 93720 T 559 322 2444 / www.hmcarchitects.com</p>		<p>Approved Project Director</p>		<p>Location VAMC FRESNO, CA</p>		<p>Drawing Number AS302 Dwg. 50 of 176</p>		<p>Department of Veterans Affairs</p>	
<p>Revisions</p>		<p>Date</p>						<p>Date March 12, 2013</p>		<p>Checked BB</p>		<p>Drawn CLO</p>	