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| Revisions | Date |
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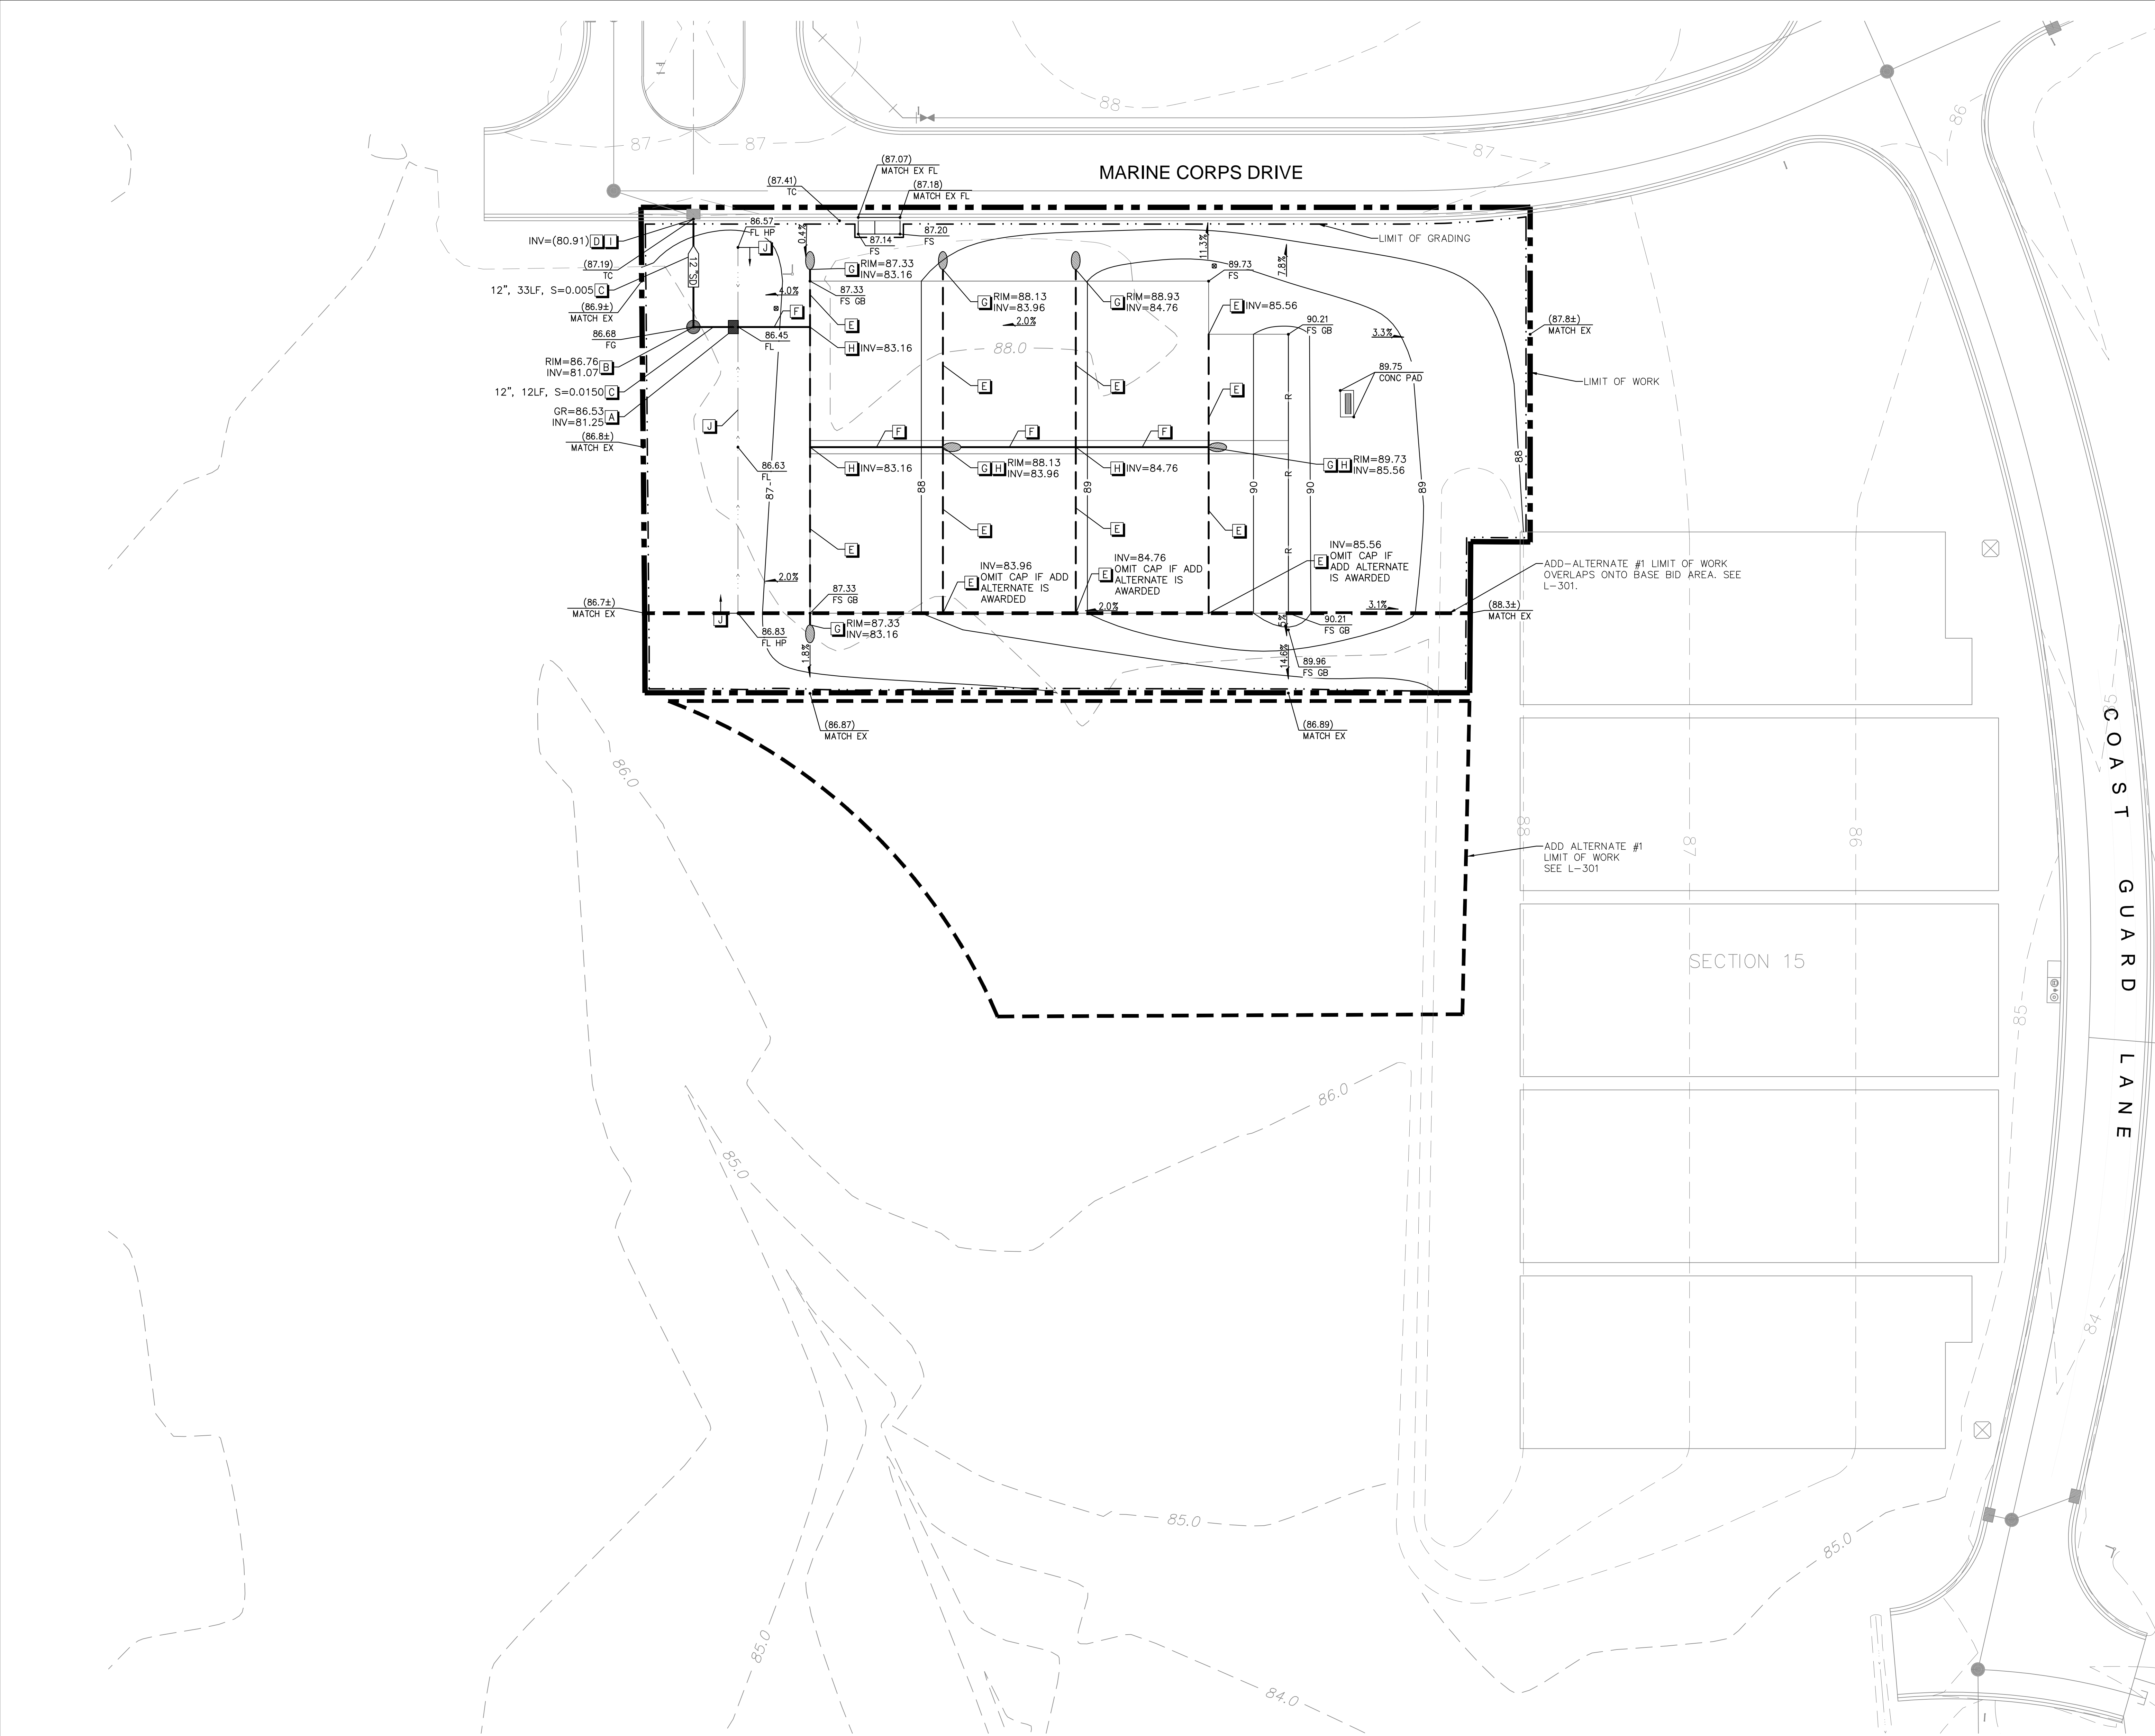
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| Subconsultant List | |
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| THE SIERRA WEST GROUP, LLC | 9700 BUSINESS PARK DRIVE, SUITE 102, SACRAMENTO, CA 95827 (916) 925-4000 |
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NATIONAL
CEMETERY
ADMINISTRATION

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|---|-------------------------|--|--|
| Sheet Title | GRADING & DRAINAGE PLAN | | |
| Approved: Director, Office of Construction Management | | | |
| Approved: Director, Project Management Service | | | |

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|-----------------|---|--------------|--|
| Project Title | LOUISIANA NATIONAL CEMETERY GRAVESITE EXPANSION PHASE 1D | | Date: AUGUST 5, 2013 |
| Building Number | Checked MIS | Drawn SGA | Project No. 870CM3023D |
| Location | LOUISIANA NATIONAL CEMETERY ZACHARY, LOUISIANA | | Sheet Reference L-300 Sht. 10 of 19 |



KEY NOTES

| KEY | SITE ELEMENT | DETAIL REFERENCE |
|-----|---|------------------|
| A | INLET WITH INVERT AND GRATE AS SHOWN. | C3 L302 |
| B | 48" SDMH WITH RIM AND INVERT AS SHOWN. | C8 L302 |
| C | SOLID WALL HDPE STORM DRAIN PIPE. SIZE, LENGTH, & SLOPE AS SHOWN, IN TRENCH. | F1 L302 |
| D | CORE OPENING & CONNECT NEW DRAIN PIPE TO EX STRUCTURE. FIELD VERIFY INVERT PRIOR TO CONSTRUCTION. | C6 L302 |
| E | 4" PERFORATED HDPE SD PIPE. CAP UPSTREAM SIDE UNLESS NOTED OTHERWISE. | F7 L302 |
| F | 4" SOLID HDPE. | C1 L302 |
| G | CLEANOUT. RIM & INVERT AS SHOWN. | C1 L302 |
| H | DRAIN TEE OR CROSS AS NEEDED. | |
| I | CONNECT TO DRAIN INLET. | |
| J | GRADE SWALE. | |

NOTES

- ALL SITE PREPARATION AND GRADING SHALL COMPLY WITH THE RECOMMENDATIONS OF THE GEOTECHNICAL INVESTIGATION AND ENGINEERING REPORT PREPARED BY W.L. BURLE ENGINEERS, P.A., DATED FEBRUARY 15, 2011 AND ANY REVISIONS AND/OR ADDENDA THERETO.
- CONTOURS SHOWN ARE A GRAPHICAL DEPICTION OF PROPOSED GRADING BASED ON COMPUTER GENERATED SURFACE MODELING AND ARE FOR REFERENCE ONLY.
- MATCH EXISTING GRADE AT ALL LIMITS OF WORK.

SITE LEGEND

| | |
|--------|-----------------------------------|
| --- | LIMIT OF WORK |
| --- | LIMIT OF WORK ADD-ALTERNATE #1 |
| --- | LIMIT OF GRADING |
| 90.50 | SPOT ELEVATION |
| (90.5) | EXISTING SPOT ELEVATION |
| 2.0% | SLOPE |
| ■ | CURB/DRAIN INLET |
| ● | STORM DRAIN MANHOLE |
| ○ | CLEANOUT |
| 12" SD | STORM DRAIN PIPE |
| --- | UNDERDRAIN |
| R | RIDGE LINE |
| 89.0 | EXISTING CONTOUR |
| 89.0 | PROPOSED CONTOUR |

KEY PLAN
L-300
NORTH
0 20 40
GRAPHIC SCALE: 1" = 20'

CONSTRUCTION DOCUMENTS