




3D **CENTER LINE OF 2' TILE DETAIL**
NOT TO SCALE

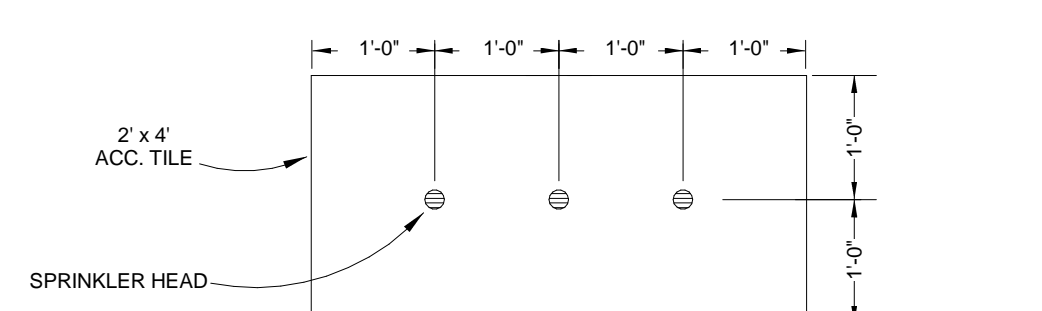

3C **CENTER LINE OF 4' TILE DETAIL**
NOT TO SCALE

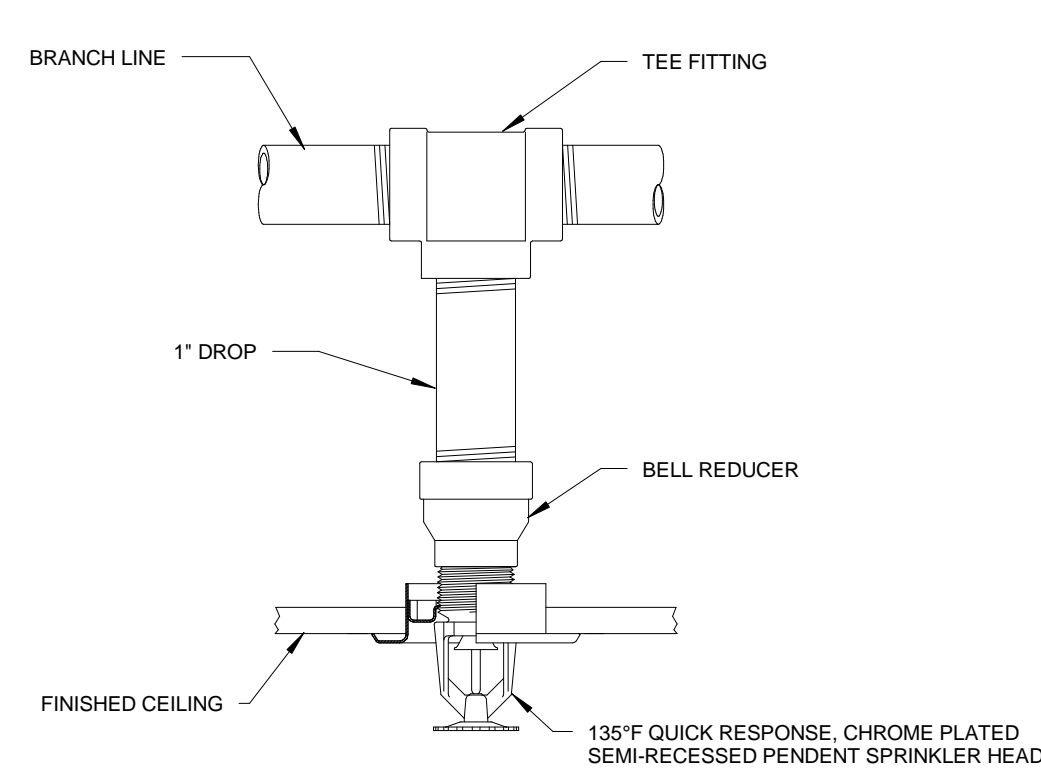

3B **SEMI-RECESSED SPRINKLER HEAD DETAIL**
NOT TO SCALE

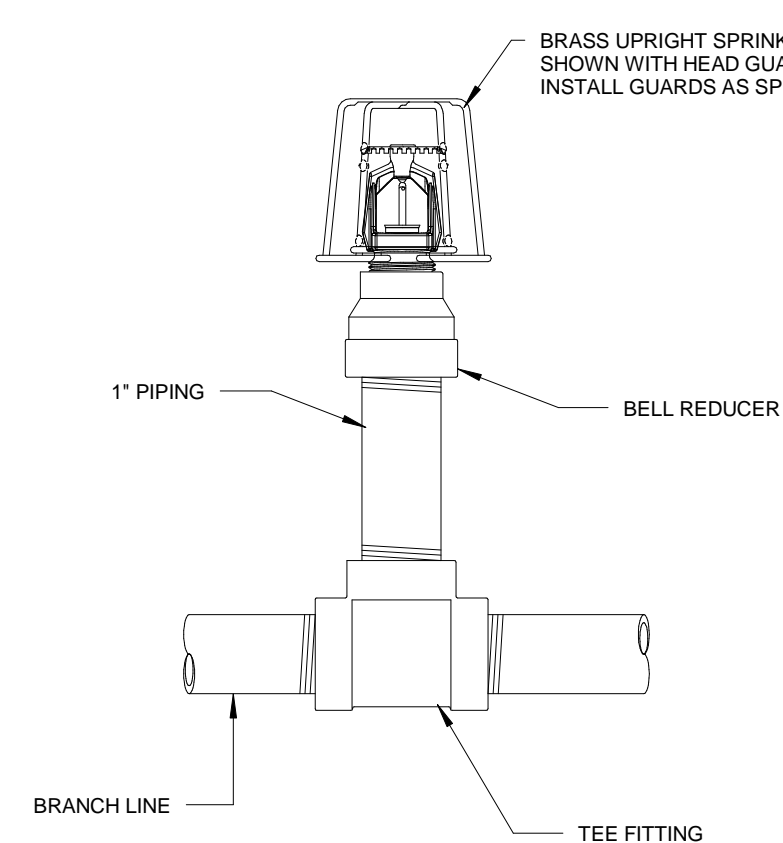

3A UPRIGHT SPRINKLER HEAD ON 1" SPRIG DETAIL
NOT TO SCALE

GENERAL NOTES:


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NOTICE TO CONTRACTORS:


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THE INSTALLING FIRE PROTECTION CONTRACTOR SHALL BE RESPONSIBLE FOR COORDINATING WITH THE GENERAL CONTRACTOR AND OTHER TRADES PRIOR TO FABRICATION AND DURING INSTALLATION. EXERCISE GREAT CARE DURING INSTALLATION TO AVOID UNNECESSARY AND UNWANTED DAMAGE TO ANY PART OR FEATURE OF THE BUILDING, EXISTING OR PLANNED. THE INSTALLING FIRE PROTECTION CONTRACTOR IS CAUTIONED TO VERIFY ANY AND ALL PENETRATIONS PRIOR TO CUTTING THROUGH WALLS, FLOORS, OR PENETRATIONS OF STRUCTURAL MEMBERS IS STRICTLY PROHIBITED WITHOUT A PROPERLY EXECUTED, WRITTEN APPROVAL. IT MAY BE NECESSARY FOR PIPES TO DROP DOWN, GO UNDER AND RISE UP AT BEAMS, OTHER STRUCTURAL FEATURES OR OTHER BUILDING SYSTEMS; AT ALL TIMES THIS SHALL BE AT CONTRACTOR'S EXPENSE.


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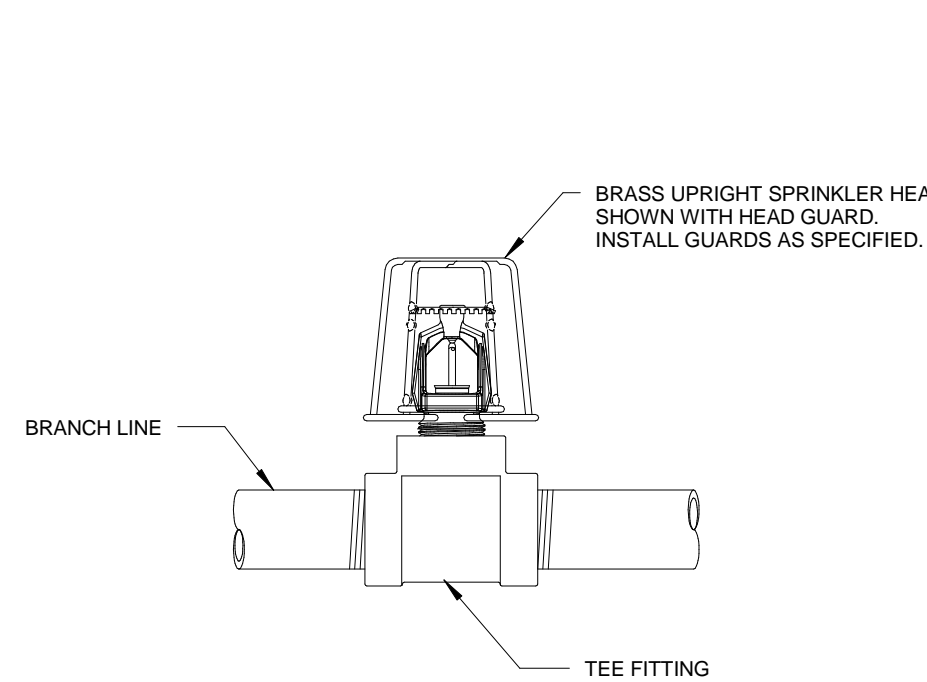
2A **FLEXIBLE SPRINKLER DROP DETAIL**
NOT TO SCALE




2B RETURN BEND DETAIL
NOT TO SCALE

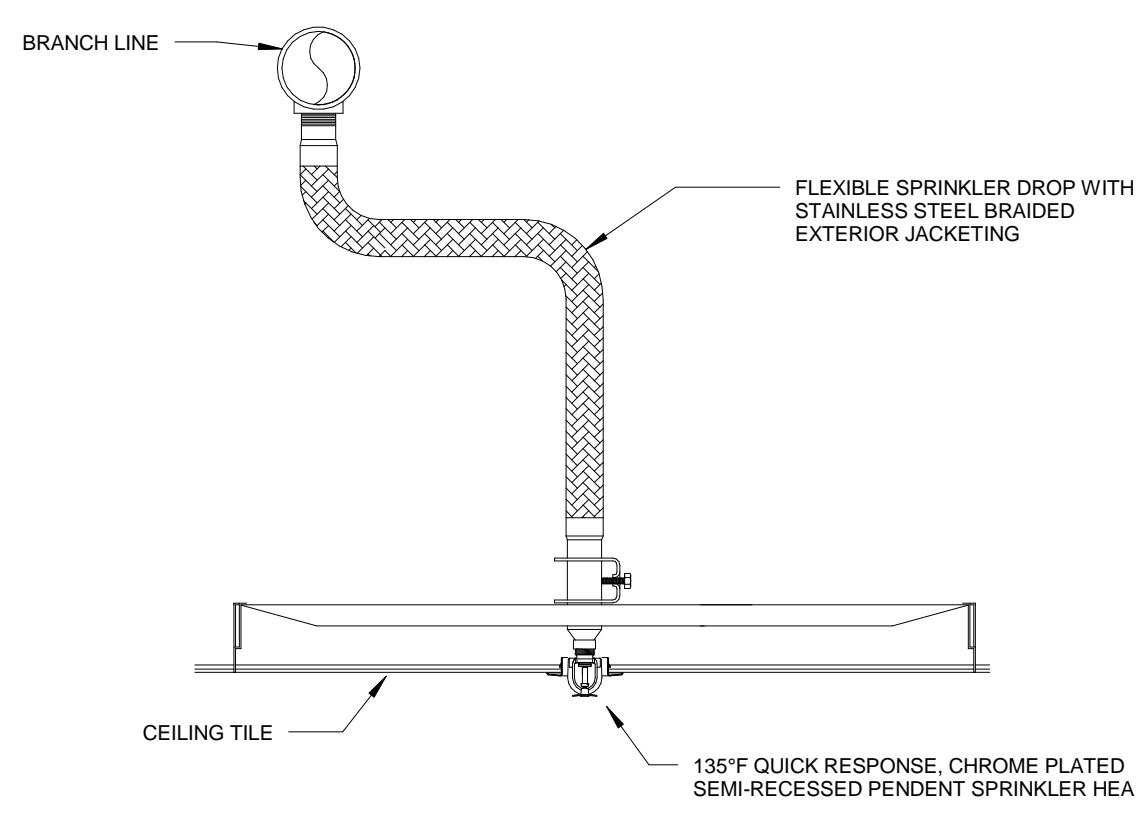

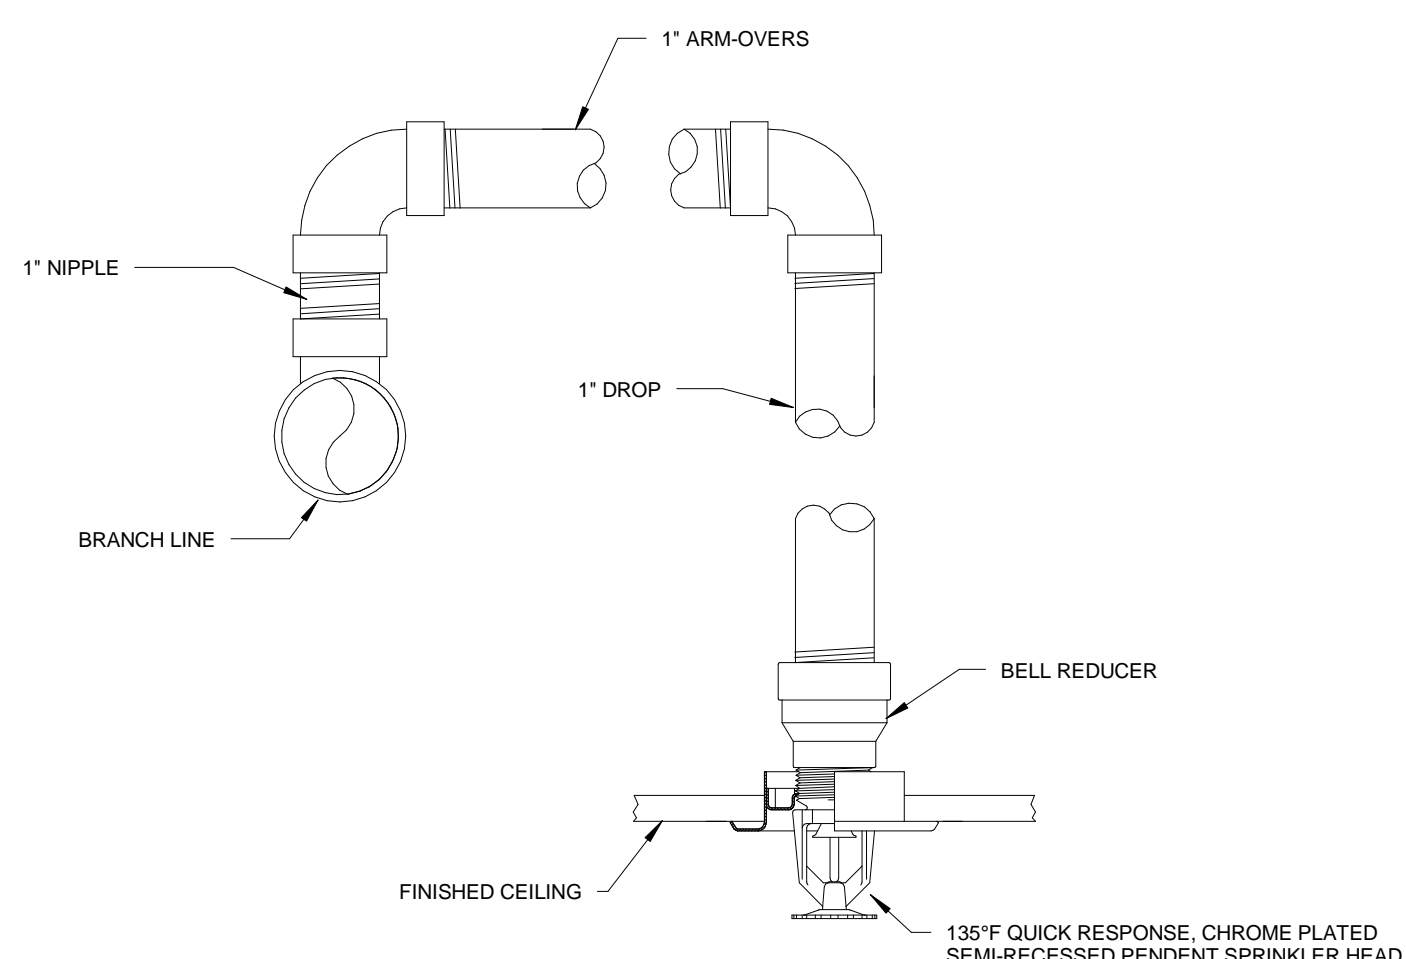
2C **RECESSED HORIZONTAL SIDEWALL SPRINKLER HEAD DETAIL**
NOT TO SCALE

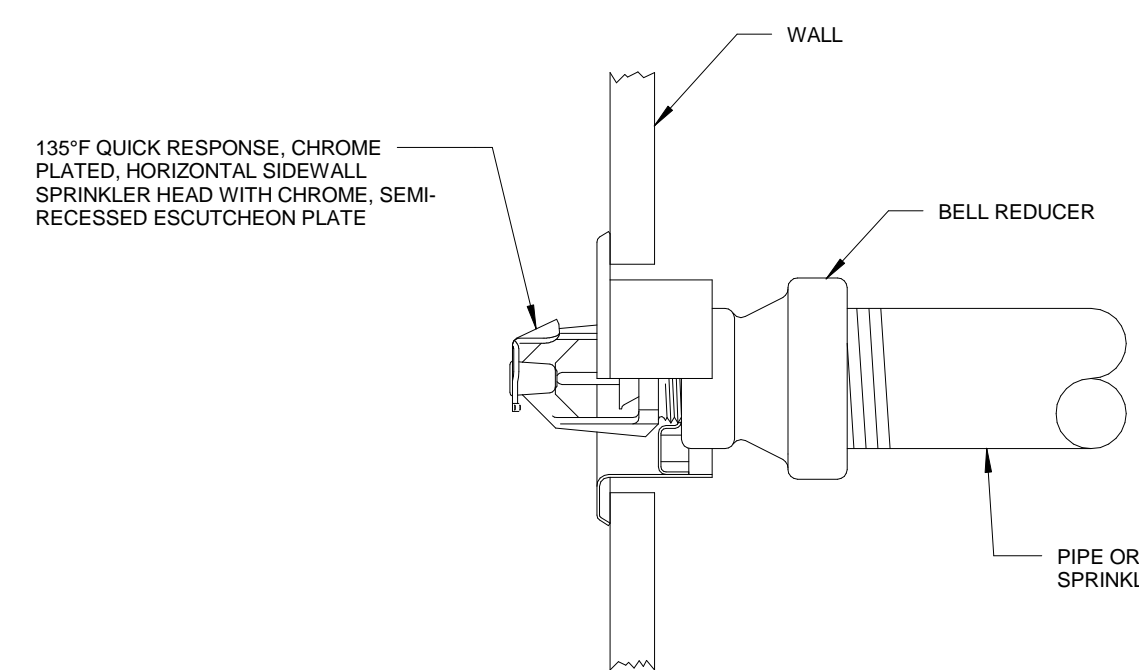


1D UPRIGHT SPRINKLER HEAD DETAIL
NOT TO SCALE

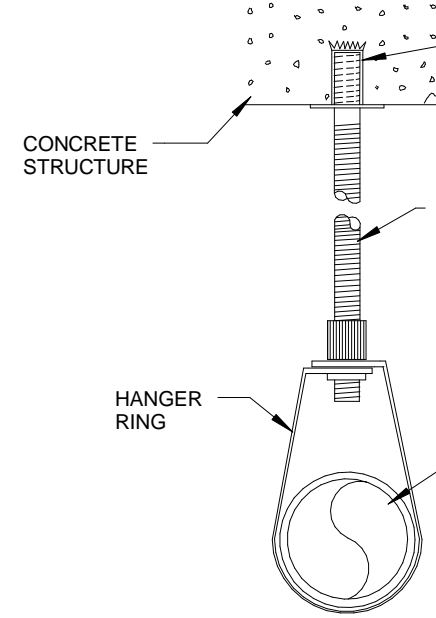

1C **CONCRETE HANGER DETAIL**
NOT TO SCALE

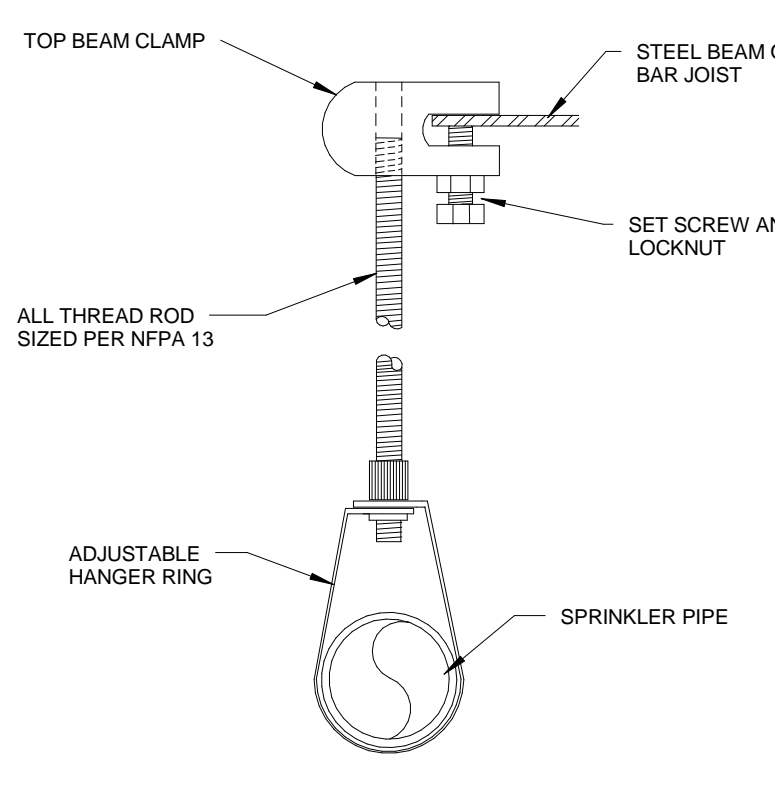

1B TOP BEAM CLAMP HANGER DETAIL
NOT TO SCALE

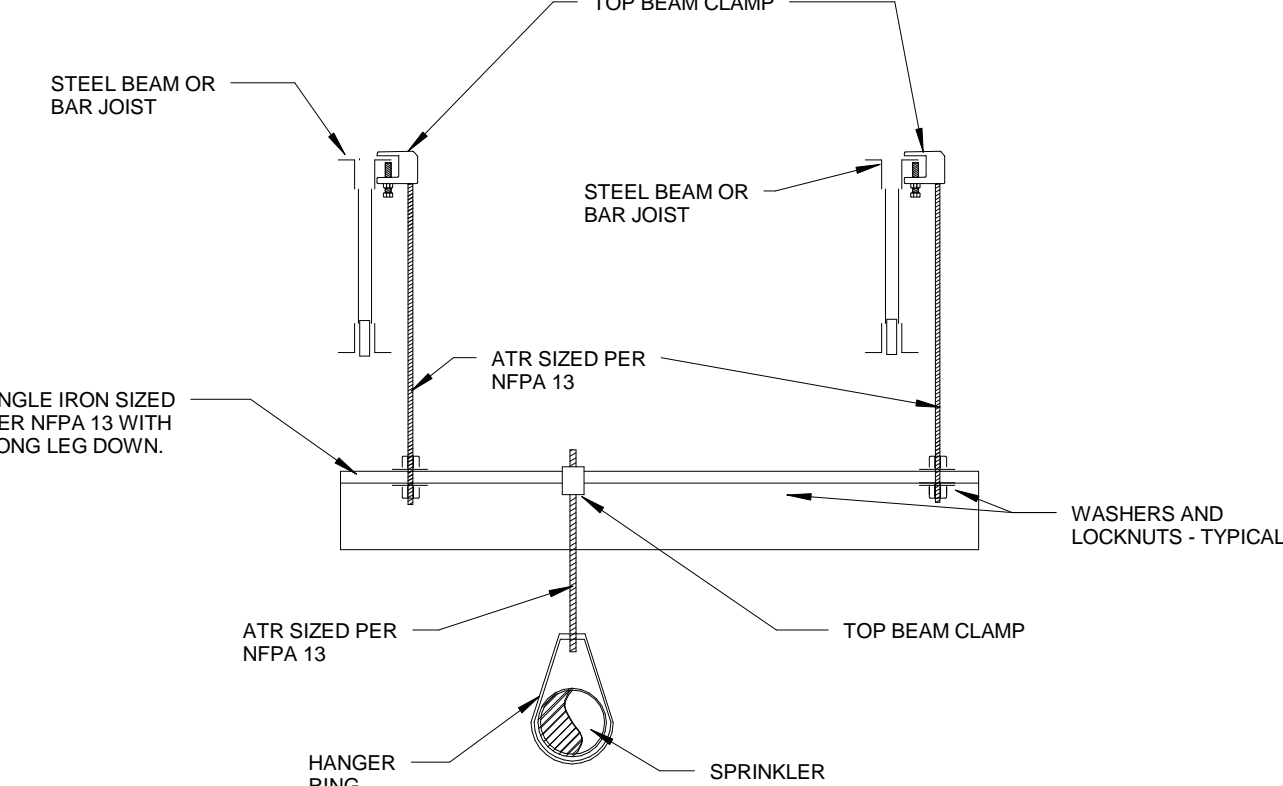

1A **TRAPEZE HANGER DETAIL**
NOT TO SCALE

100% Construction Documents	08/29/13
100% Construction Documents	04/09/12
95% Construction Documents	03/14/12
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Phone: (405) 463-6570
Fax: (405) 463-6573
tme@tme corp.com
#06-10-0039
OK COA #2637 EXPIRES 06/30/15

Drawing Title
GENERAL NOTES AND DETAILS - FIRE PROTECTION
Medical Center Director:
Chief Engineer:


Project Title	1st and 2nd Floor Clinic Expansion Oklahoma City VA Medical Center
Location	V.A.M.C. Oklahoma City, OK

Project Number	635-408
Building Number	1
Drawing Number	70




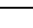



Office of
Construction
and Facilities
Management

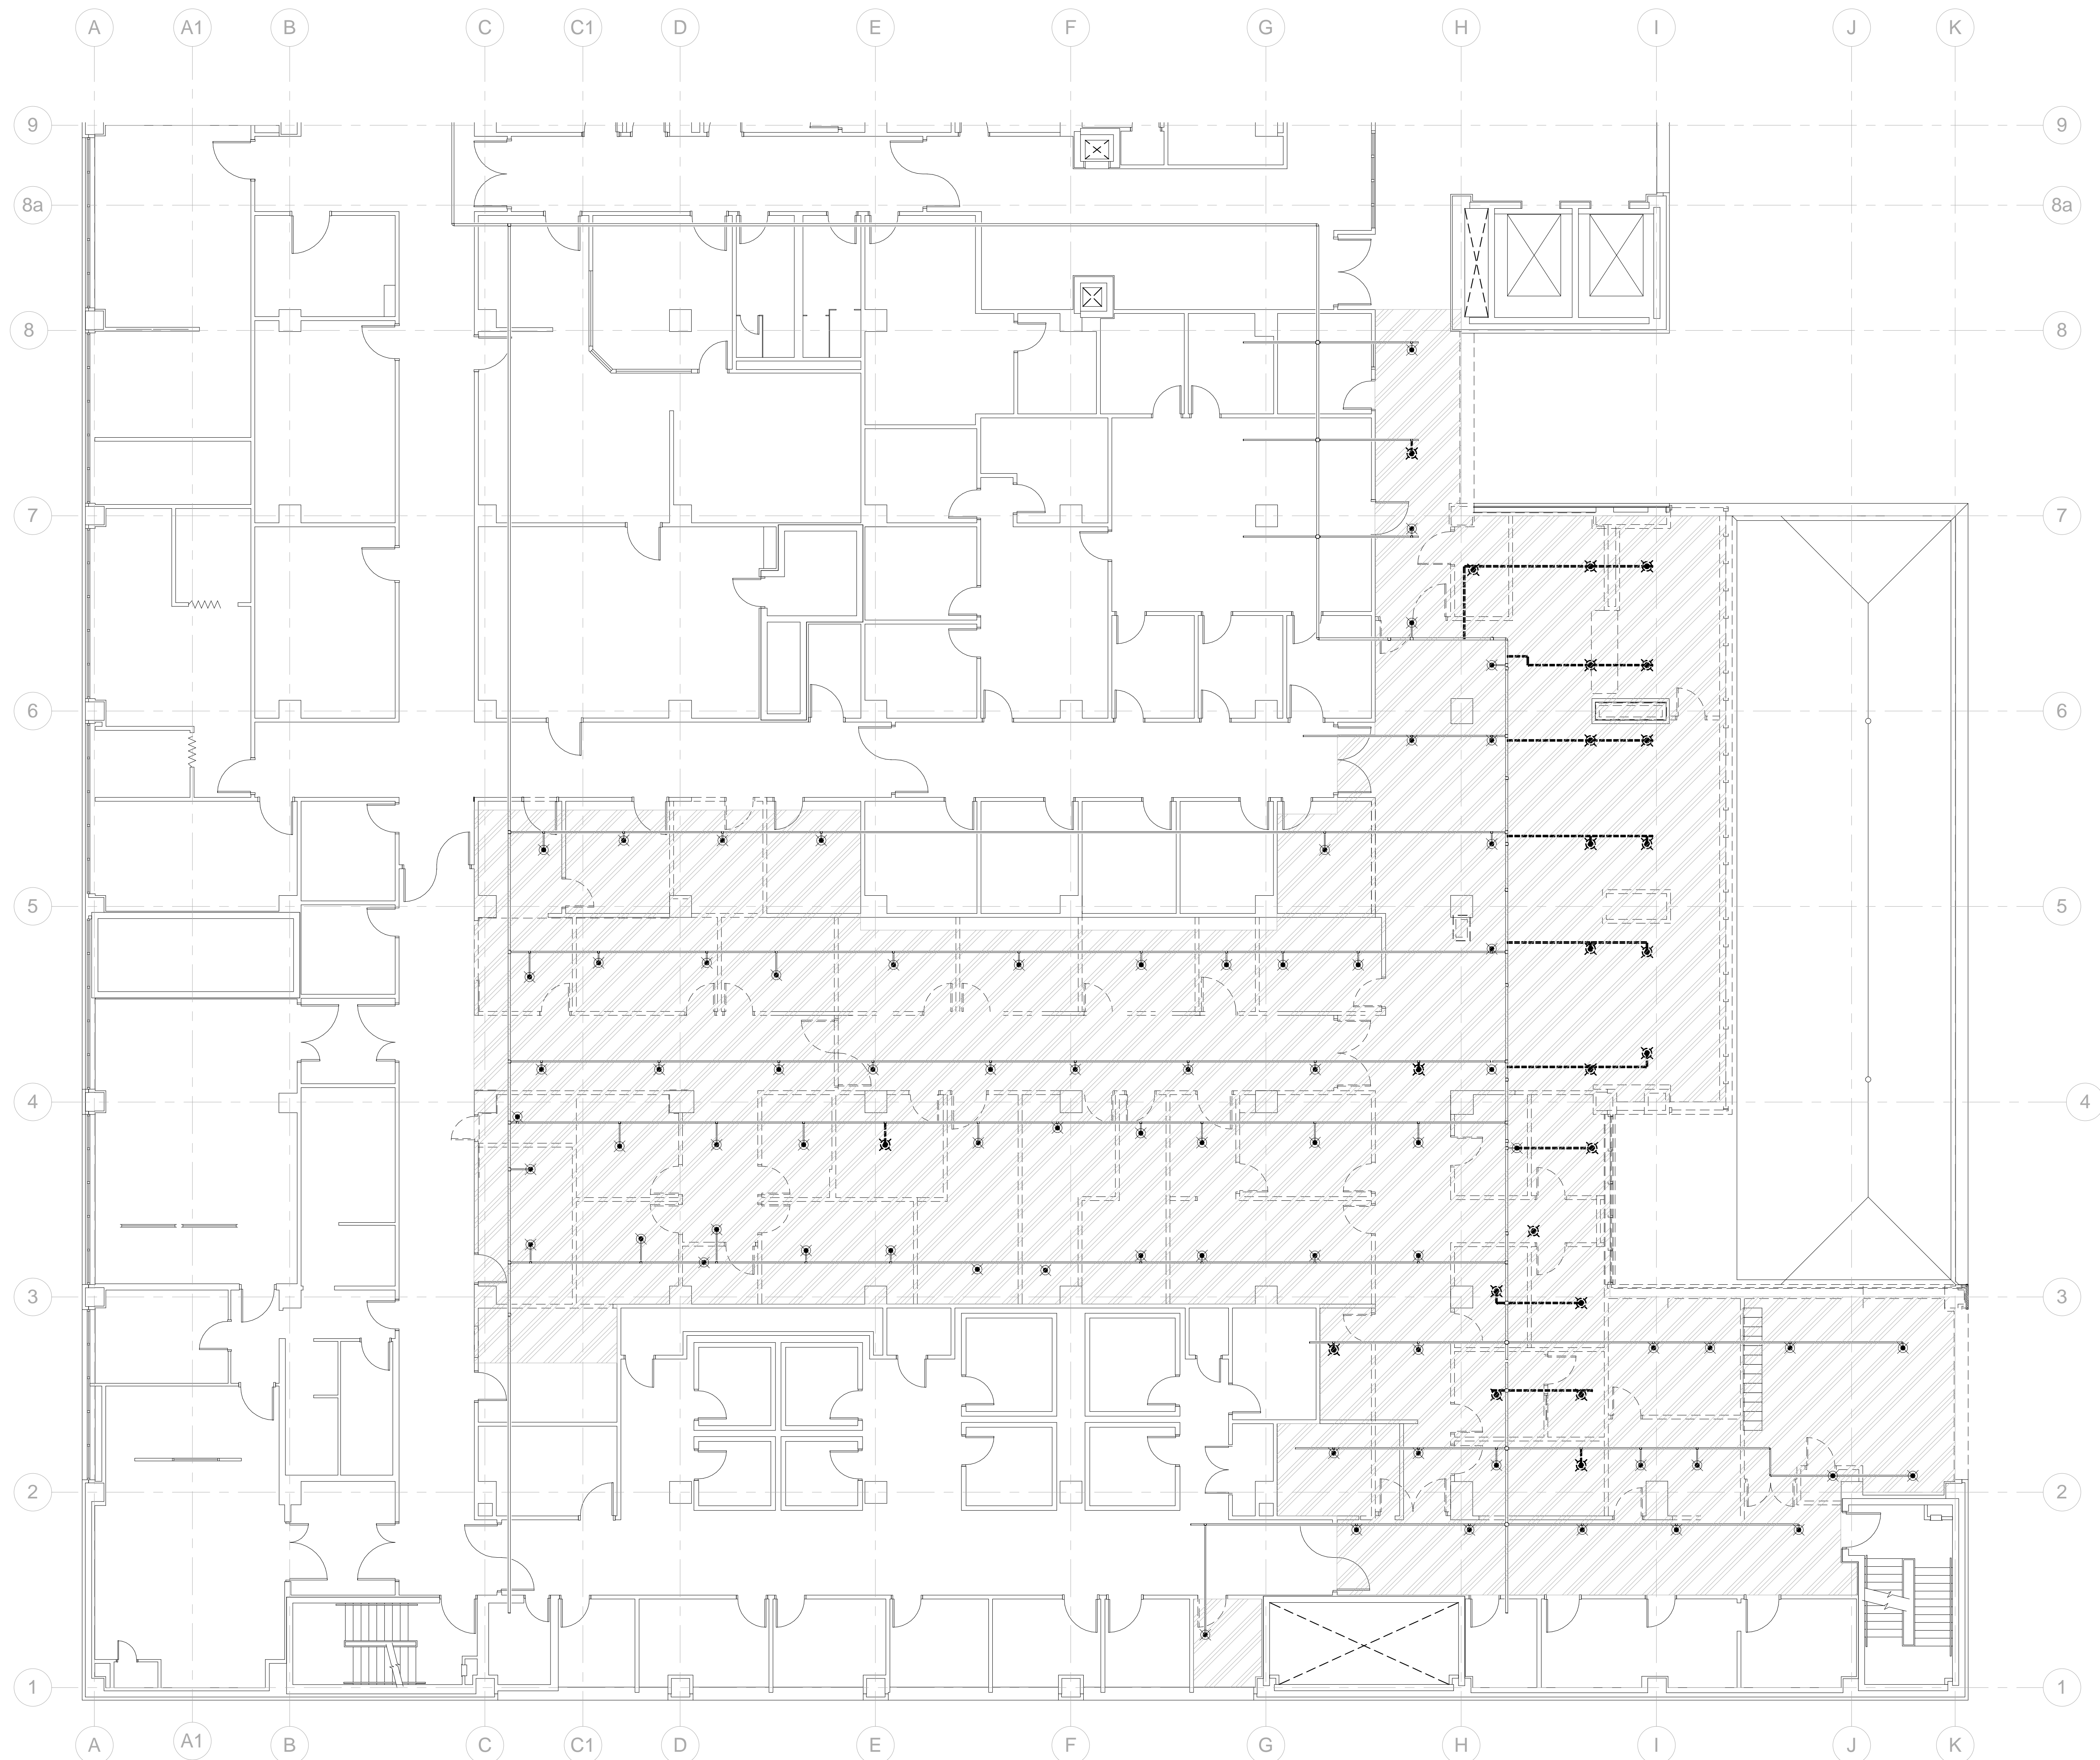Department of
Veterans Affairs

FULLY SPRINKLERED



FIRE PROTECTION LEGEND

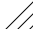- | | |
|---|--|
|  | EXISTING SPRINKLER HEAD ON DROP
- TO BE LEFT IN PLACE OR USED AS
OUTLET TO SUPPLY NEW AREA-COVER
APPROXIMATE LOCATION(S) SHOWN. |
|  | NEW SPRINKLER HEAD LOCATION.
135°F. CHROME, SEMI-RECESSED,
QUICK RESPONSE. |
|  | CONNECT TO EXISTING |
|  | EXISTING |
|  | NEW |
|  | DEMOLISH |
|  | LIMITS OF FIRE PROTECTION
WORK THIS FLOOR |

NOTICE TO CONTRACTORS:

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THIRD FLOOR WORK:

THERE IS AN EXISTING THIRD FLOOR MECHANICAL ROOM, IN WHICH A NEW AIR HANDLER IS TO BE INSTALLED. HVAC DUCTWORK WILL BE ADDED AND MODIFIED AS REQUIRED. THEREFORE, IT WILL BE NECESSARY TO MODIFY THE EXISTING FIRE PROTECTION SPRINKLER HEADS & ASSOCIATED PIPING TO BE IN COMPLIANCE WITH ALL V.A., NFPA AND LOCAL CODE REQUIREMENTS. REFER TO MECHANICAL SHEETS FOR ROOM LAYOUT. PERFORM FIELD SURVEY PRIOR TO BID AND DESIGN.

DEMOLITION NOTES:

1. THE INTENT OF THE PROJECT IS TO REUSE AS MUCH OF THE EXISTING SYSTEM PIPING AS POSSIBLE. SO LONG AS THE PIPING IS NOT EXPOSED TO EXCESSIVE HEAT, DEMOLITION, MOST DEMOLITION WILL TAKE PLACE UNDER THE NEW FLOORING. DEMOLITION OF THE EXISTING PIPING WILL BE LIMITED TO SUPPLY NEW ARM-OVERS TO NEW SPRINKLER HEAD LOCATIONS.
2. CONFLICTS ARE TO BE EXPECTED ANYWHERE THE EXISTING SPRINKLER SYSTEM PIPING NETWORK AND THE NEW LIGHTING SYSTEMS ARE TO BE INSTALLED. SHOWN ON THESE DRAWINGS OR NOT, THE LOCATIONS OF EXISTING LIGHTING FIXTURES SHALL TAKE PRIORITY OVER THE NEW LIGHTING. THE NEW LIGHTING SHALL BE INSTALLED TO THE EXISTING SYSTEM PIPING SHALL BE OFFSET UP-OVER-DOWN, OR SIDE-TO-SIDE WHERE NECESSARY TO AVOID OR FACILITATE THE NEW LIGHTING LAYOUT.
3. DEMOLITION OF THE EXISTING SPRINKLER SYSTEMS IS TO BE TAKEN BACK TO THE BRANCH LINE, OR THE CROSS MAIN AND PLUGS OR NIPPLES WITH CAPS SHALL BE LEFT IN PLACE. THERE SHALL BE NO REMOVAL OF ANY PORTIONS OF THE EXISTING BRANCH LINE PIPING REMAINING INTACT THAN WHAT IS NECESSARY TO FACILITATE THE REMOVAL OF IT SHALL NOT BE ACCEPTABLE TO ABANDON ANY PIPES IN PLACE ABOVE CEILING.
4. SURRENDER ALL DEMOLISHED MATERIALS (PIPES, FITTINGS, HANGERS, ESPECIALLY SPRINKLER HEADS) TO THE OWNER FOR FIRST RIGHT OF REFUSAL.

FIRST FLOOR DEMOLITION - FIRE PROTECTION

100% Construction Documents	08/29/13
100% Construction Documents	04/09/12
95% Construction Documents	03/14/12
65% Design Development	01/23/12
35% Schematic Design Revised	11/09/11
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HEALTHCARE CONSULTANT
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Phone: (405) 463-6570
Fax: (405) 463-6573
tme@tmeCorp.com
#06-10-0039
OK COA #2637 EXPIRES 06/30/15

Drawing Title
FIRST FLOOR PLAN - DEMOLITION -
FIRE PROTECTION

Medical Center Director:

Chief Engineer:

Project Title	1st and 2nd Floor Clinic Expansion Oklahoma City VA Medical Center
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Location	V.A.M.C. Oklahoma City, OK
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Date

oma City,

Checked	
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Project Number

Building Number

1


FD101

Office of
Construction
and Facilities
Management



FULLY SPRINKLERED

three inches = one foot
one and one half inches = one foot
one inch = one foot
three quarters inch = one foot
one half inch = one foot
three eighths inch = one foot
one quarter inch = one foot
one eighth inch = one foot

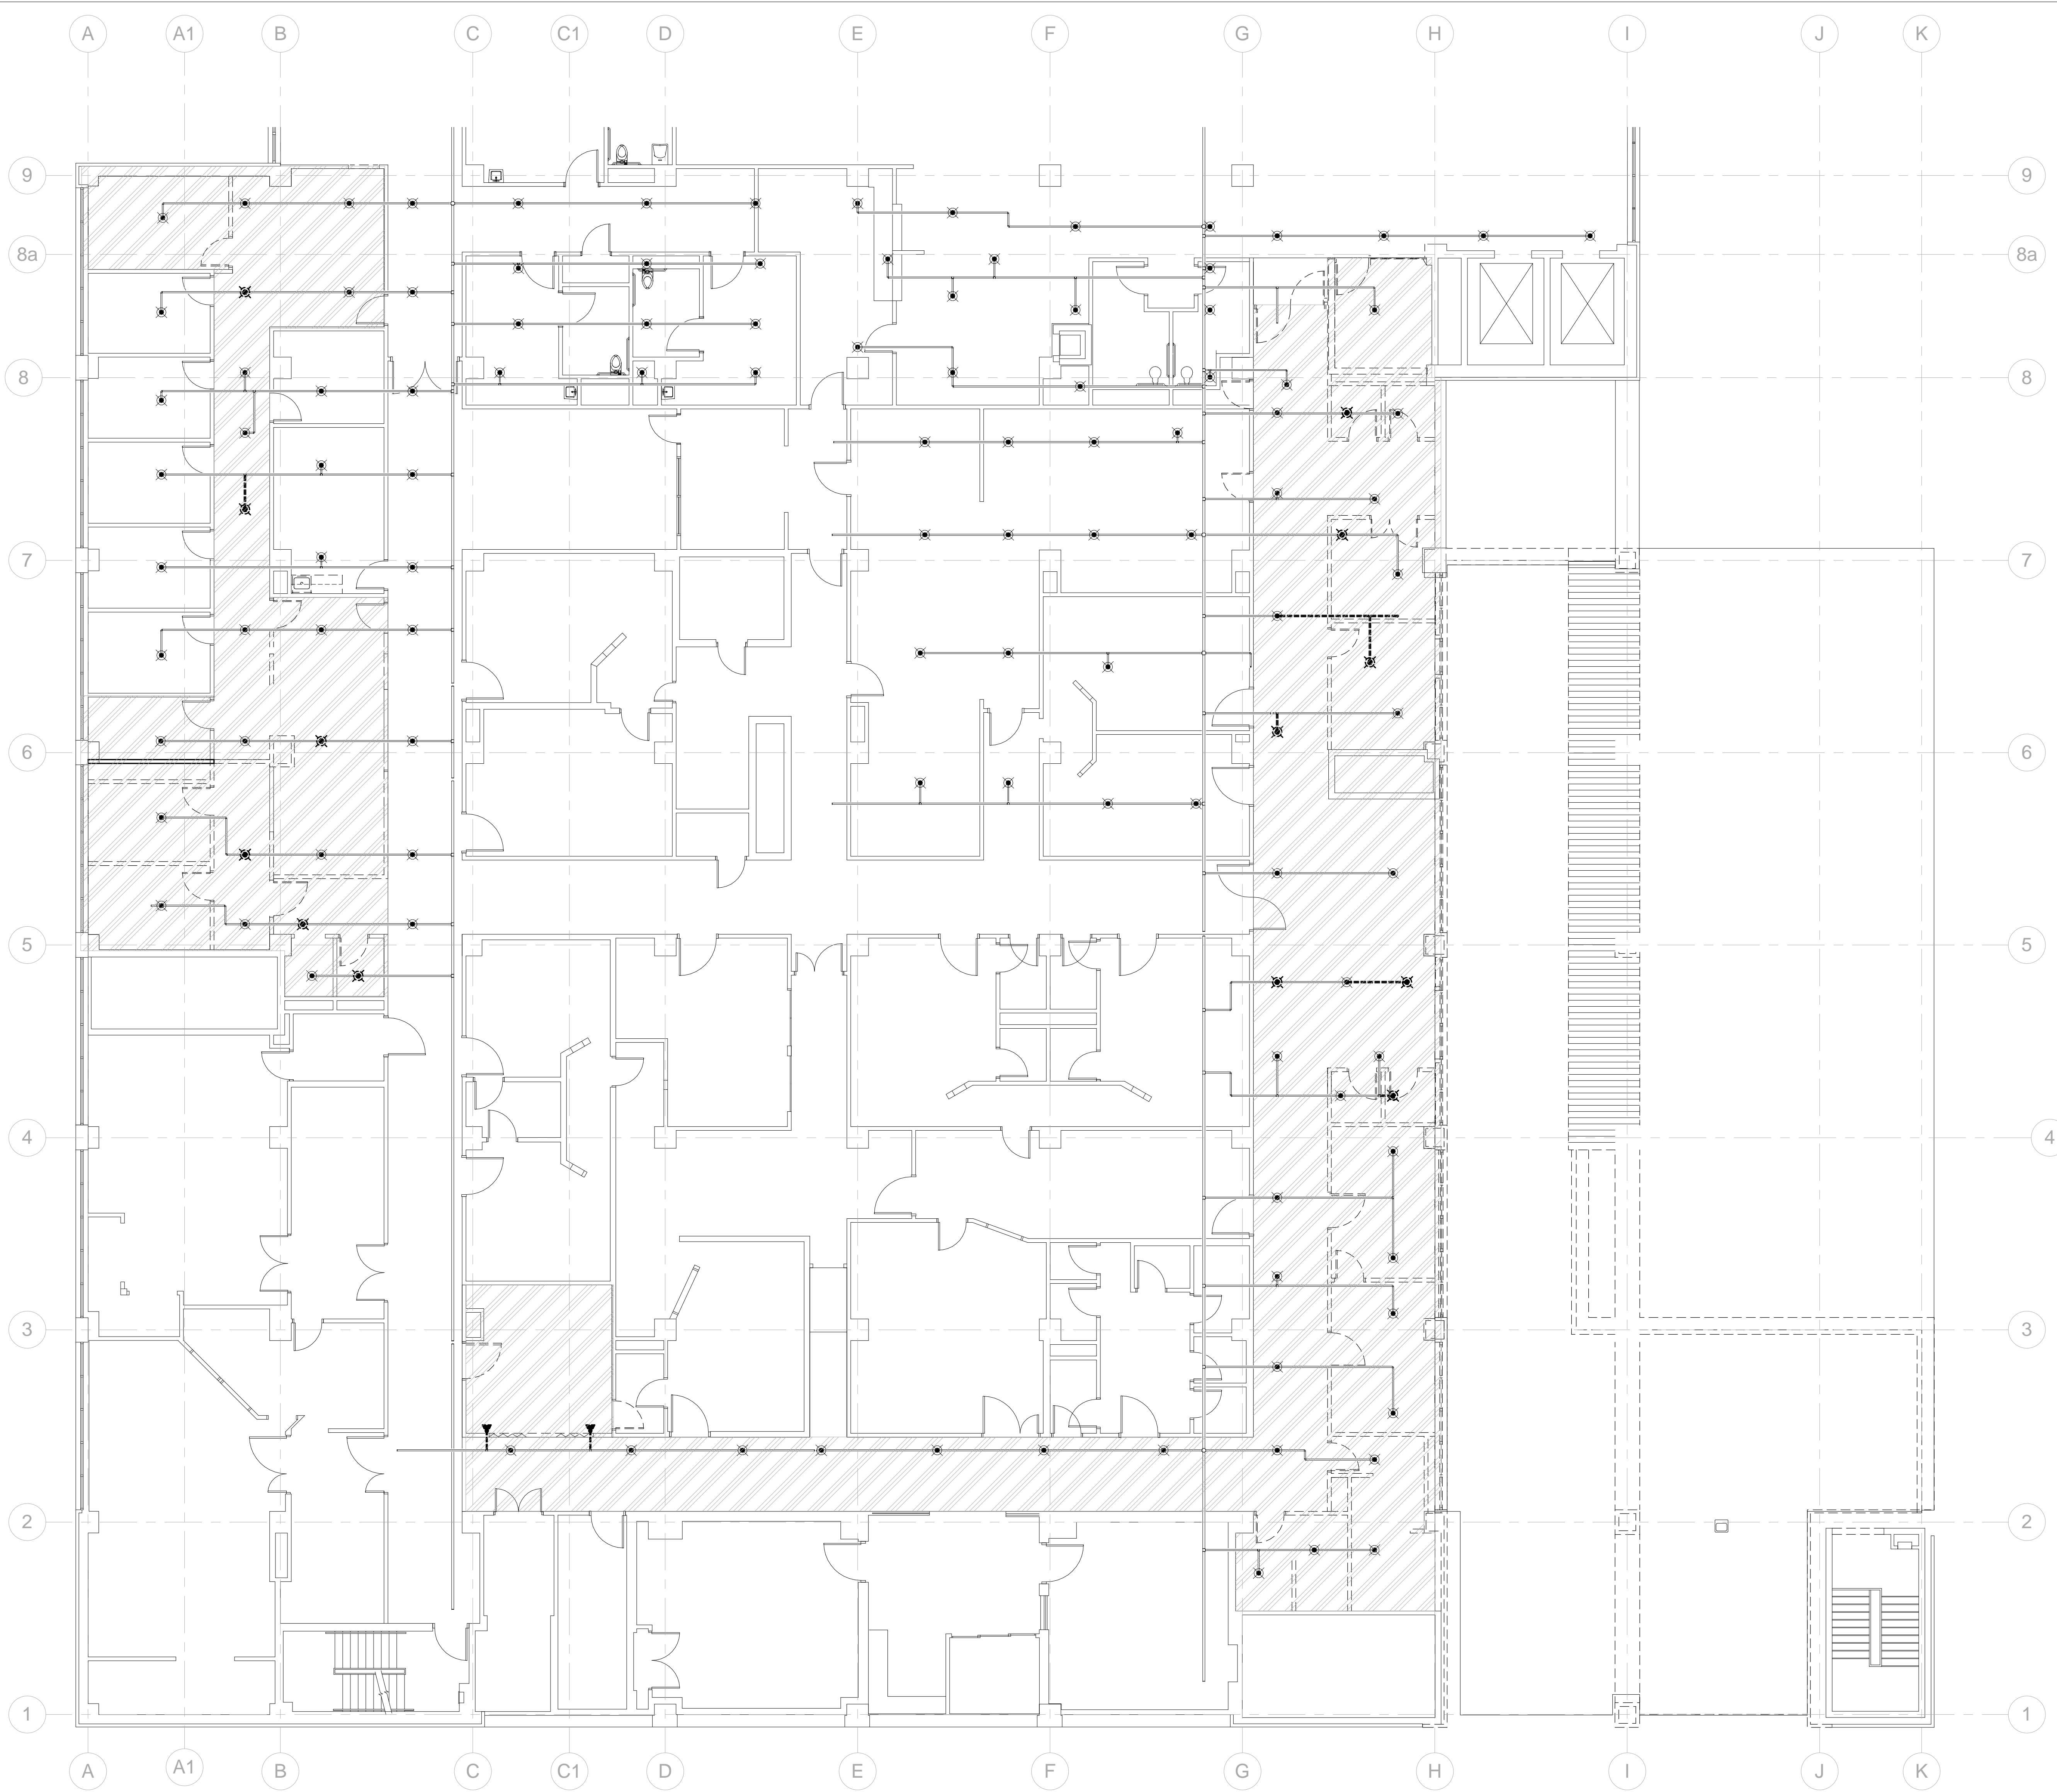

FIRE PROTECTION LEGEND

EXISTING SPRINKLER HEAD ON DROP - TO BE LEFT IN PLACE OR USED AS OUTLET TO SUPPLY NEW ARM-OVER APPROXIMATE LOCATIONS SHOWN.

NEW SPRINKLER HEAD LOCATION. 135°F, CHROME, SEMI-RECESSED, QUICK RESPONSE.

CONNECT TO EXISTING

EXISTING

NEW

DEMOLISH

LIMITS OF FIRE PROTECTION WORK THIS FLOOR

NOTICE TO CONTRACTORS:
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DEMOLITION NOTES:
1. THE INTENT OF THE PROJECT IS TO RE-USE AS MUCH OF THE EXISTING SYSTEM PIPING AS POSSIBLE. SO THERE IS NOT EXPECTED TO BE SUBSTANTIAL DEMOLITION. MOST DEMOLITION WILL TAKE PLACE DURING THE RENOVATION. EXISTING 'I' OUTLETS MAY BE RE-USED TO SUPPLY NEW ARM-OVERS TO NEW SPRINKLER HEAD LOCATIONS.

2. CONFLICTS ARE TO BE EXPECTED ANYWHERE THE EXISTING SPRINKLER SYSTEM PIPING NETWORK AND THE NEW LIGHTING LAYOUT INTERSECT. WHETHER SHOWN ON THESE DRAWINGS OR NOT, THE LOCATIONS OF LIGHTING FIXTURES SHALL TAKE PRIORITY OVER THE SPRINKLER HEAD LOCATIONS, AND THE SPRINKLER SYSTEM PIPING SHALL BE OFFSET 'UP-OVER-DOWN', OR AROUND, OR WHATEVER MAY BE NECESSARY TO FACILITATE THE NEW LIGHTING LAYOUT.

3. DEMOLITION OF THE EXISTING SPRINKLER SYSTEMS IS TO BE TAKEN BACK TO THE BRANCH LINE, OR THE CROSS MAIN AND PLUGS OR NIPPLES WITH CAPS SHALL BE INSTALLED. THERE ARE TO BE ABSOLUTELY NO MORE PORTIONS OF THE EXISTING BRANCH LINE PIPING REMAINING INTACT THAN WHAT ARE NECESSARY TO FACILITATE THE RENOVATION. IT SHALL NOT BE ACCEPTABLE TO ABANDON ANY PIPES IN PLACE ABOVE CEILING.

4. SURRENDER ALL DEMOLISHED MATERIALS (PIPES, FITTINGS, HANGERS, ESPECIALLY SPRINKLER HEADS) TO THE OWNER FOR FIRST RIGHT OF REFUSAL.

1

SECOND FLOOR DEMOLITION - FIRE PROTECTION
1/8" = 1'-0"

100% Construction Documents	08/29/13
100% Construction Documents	04/09/12
95% Construction Documents	03/14/12
65% Design Development	01/23/12
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35% Schematic Design	10/07/11
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tme@tmeccorp.com
#06-10-0039
OK COA #2637 EXPIRES 06/30/15

Drawing Title
SECOND FLOOR PLAN - DEMOLITION - FIRE PROTECTION
Medical Center Director:

Chief Engineer:

Project Title
1st and 2nd Floor Clinic Expansion
Oklahoma City VA Medical Center

Location
V.A.M.C. Oklahoma City, OK

Date
08/30/13

Checked
GS

Drawn
GS


Project Number
635-408
Building Number
1

Drawing Number
FD102





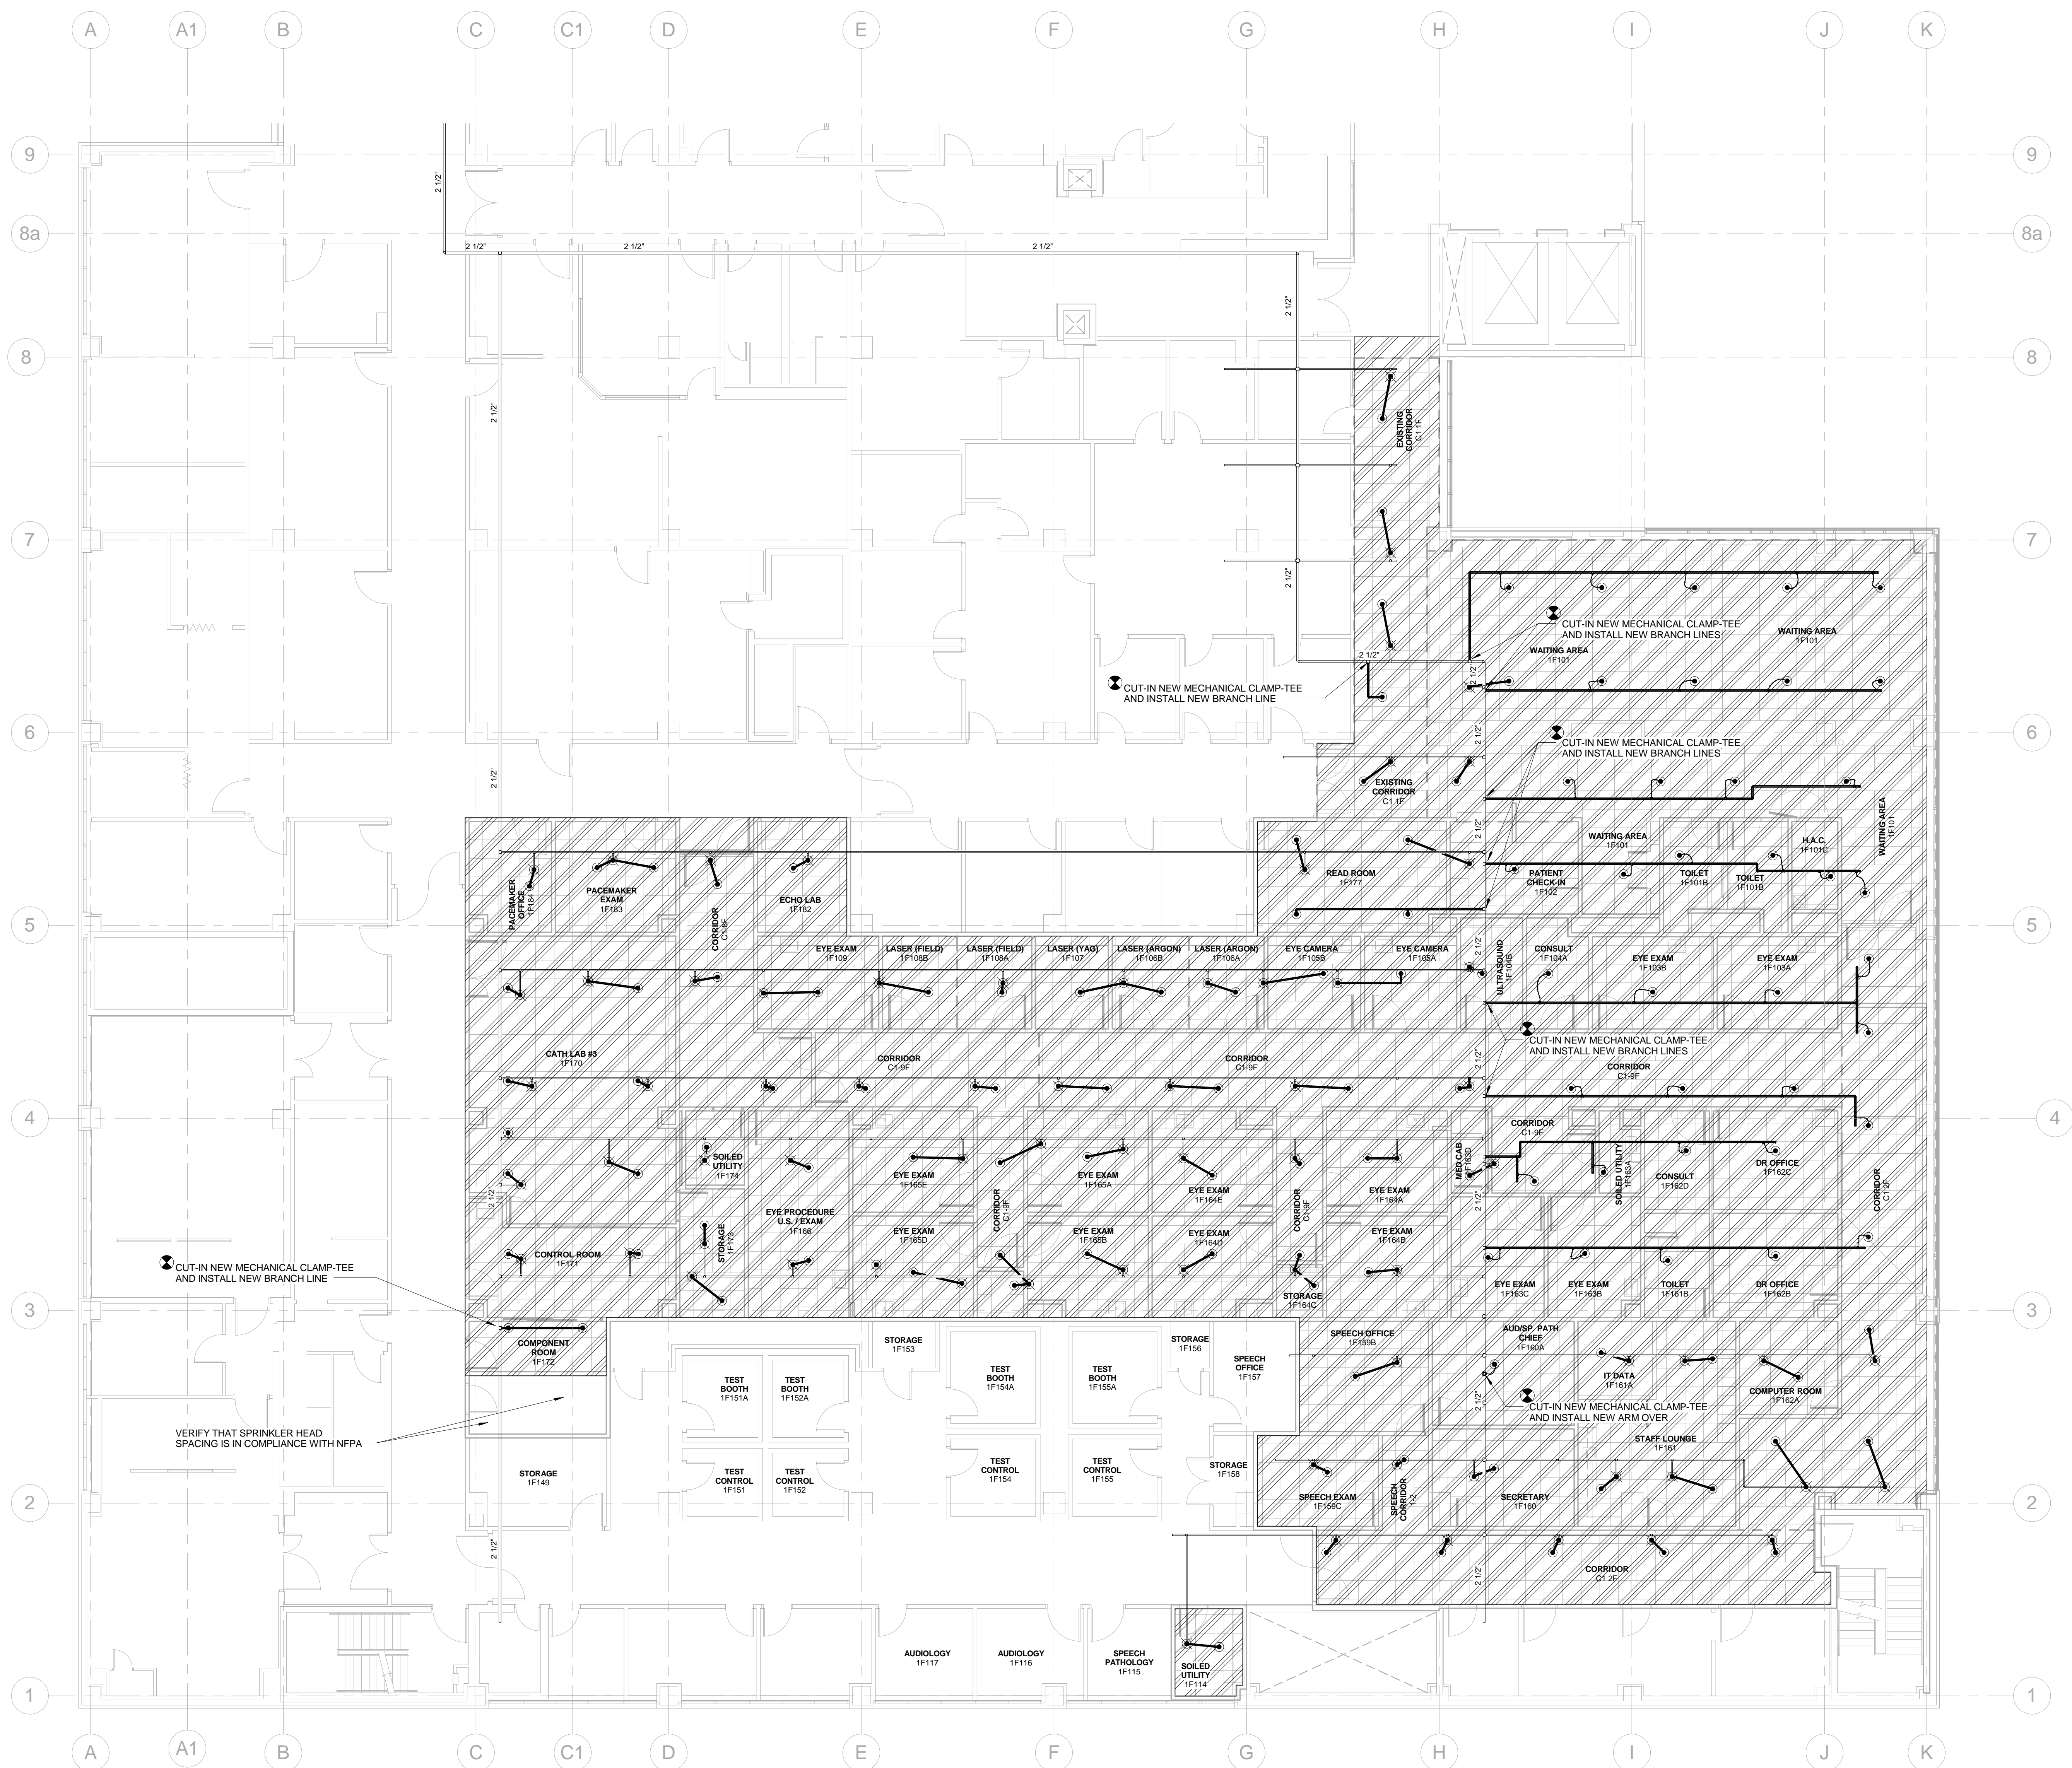

Office of
Construction
and Facilities
Management

Department of
Veterans Affairs

FULLY SPRINKLERED



FIRE PROTECTION LEGEND

- | | |
|---|---|
|  | EXISTING SPRINKLER HEAD ON DROP - TO BE LEFT IN PLACE OR USED AS OUTLET TO SUPPLY NEW ARM-OVER APPROXIMATE LOCATIONS SHOWN. |
|  | NEW SPRINKLER HEAD LOCATION. 135°F, CHROME, SEMI-RECESSED, QUICK RESPONSE. |
|  | CONNECT TO EXISTING |
|  | EXISTING |
|  | NEW |
|  | DEMOLISH |

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THERE IS AN EXISTING THIRD FLOOR MECHANICAL ROOM, IN WHICH A NEW AIR HANDLER IS TO BE INSTALLED. HVAC DUCTWORK WILL BE ADDED AND MODIFIED AS REQUIRED. THEREFORE, IT WILL BE NECESSARY TO MODIFY THE EXISTING FIRE PROTECTION SPRINKLER HEADS & ASSOCIATED PIPING TO BE IN COMPLIANCE WITH ALL V.A., NFPA AND LOCAL CODE REQUIREMENTS. REFER TO MECHANICAL SHEETS FOR ROOM LAYOUT. PERFORM FIELD SURVEY PRIOR TO BID AND DESIGN.

INTENT:

1. OUTSIDE OF THE NEW ADDITIONS OF THIS PROJECT, IT SHALL BE THE INTENT TO RE-USE ALMOST 100% OF THE EXISTING FIRE PROTECTION SYSTEM AS IT IS CURRENTLY INSTALLED. SOME PIPES MAY NEED TO BE RAISED DUE TO NEW CEILING HEIGHTS OR FOR COORDINATION WITH OTHER DISCIPLINES.

2. REPLACE ALL EXISTING SPRINKLER HEADS WITHIN THE SMALL ROOMS & SPACES OF RENOVATION TO INSURE INTEGRITY OF DEVICES IS MAINTAINED. REMOVE LINKS / BULBS FROM SPRINKLERS. SURRENDER ALL DEMOLISHED SPRINKLER HEADS AND OTHER MATERIALS TO THE OWNER FOR FIRST RIGHT OF REFUSAL.

3. INSTALL PLUGS OR NIPPLES WITH CAPS WHEN ARM-OR-OR BRANCH LINES ARE DEMOLISHED. IT SHALL NOT BE ACCEPTABLE TO ABANDON / LEAVE PIPES IN PLACE THAT NOT FEED SPRINKLER HEADS.

FIRST FLOOR RENOVATION - FIRE PROTECTION

$$1/8'' = 1'-0''$$

100% Construction Documents	08/29/13
100% Construction Documents	04/09/12
95% Construction Documents	03/14/12
65% Design Development	01/23/12
35% Schematic Design Revised	11/09/11
35% Schematic Design	10/07/11
Revisions:	Date

ARCHITECTS/ENGINEERS/CONSULTANTS:


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STRUCTURAL ENGINEER
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JUNK ARCHITECTS
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COST ESTIMATOR :
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OK COA #2637 EXPIRES 06/30/15

Drawing Title
FIRST FLOOR PLAN - RENOVATION -
FIRE PROTECTION

Medical Center Director

Chief Engineer:

Project Title	1st and 2nd Floor Clinic Expansion Oklahoma City VA Medical Center
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Location	V.A.M.C. Oklahoma City, OK
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Date
08/30/13

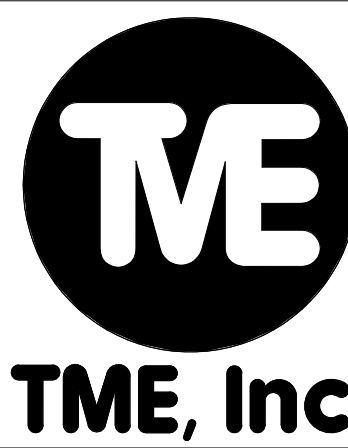Checked
GS

Drawn
GS

Project Number

Building Number

Drawing Number

FX201

Office of
Construction
and Facilities
Management



FUJII Y SPRINKI FRED

