

I HEREBY CERTIFY THAT THESE PLANS AND SPECIFICATIONS WERE PREPARED BY ME OR UNDER MY CLOSE PERSONAL SUPERVISION AND TO THE BEST OF MY KNOWLEDGE AND BELIEF THEY COMPLY WITH ALL CITY, STATE AND FEDERAL REQUIREMENTS AND ORDINANCES FOR CODES AND

I HAVE PREPARED OR CAUSED TO BE PREPARED THESE PLANS AND SPECIFICATIONS AND I AM A duly Licensed Professional Engineer and I STATE THAT TO THE BEST OF MY KNOWLEDGE AND BELIEF THEY COMPLY WITH ALL CITY, STATE AND FEDERAL REQUIREMENTS AND ORDINANCES FOR CODES AND

L.B. HERBST & ASSOCIATES, INC. 2018

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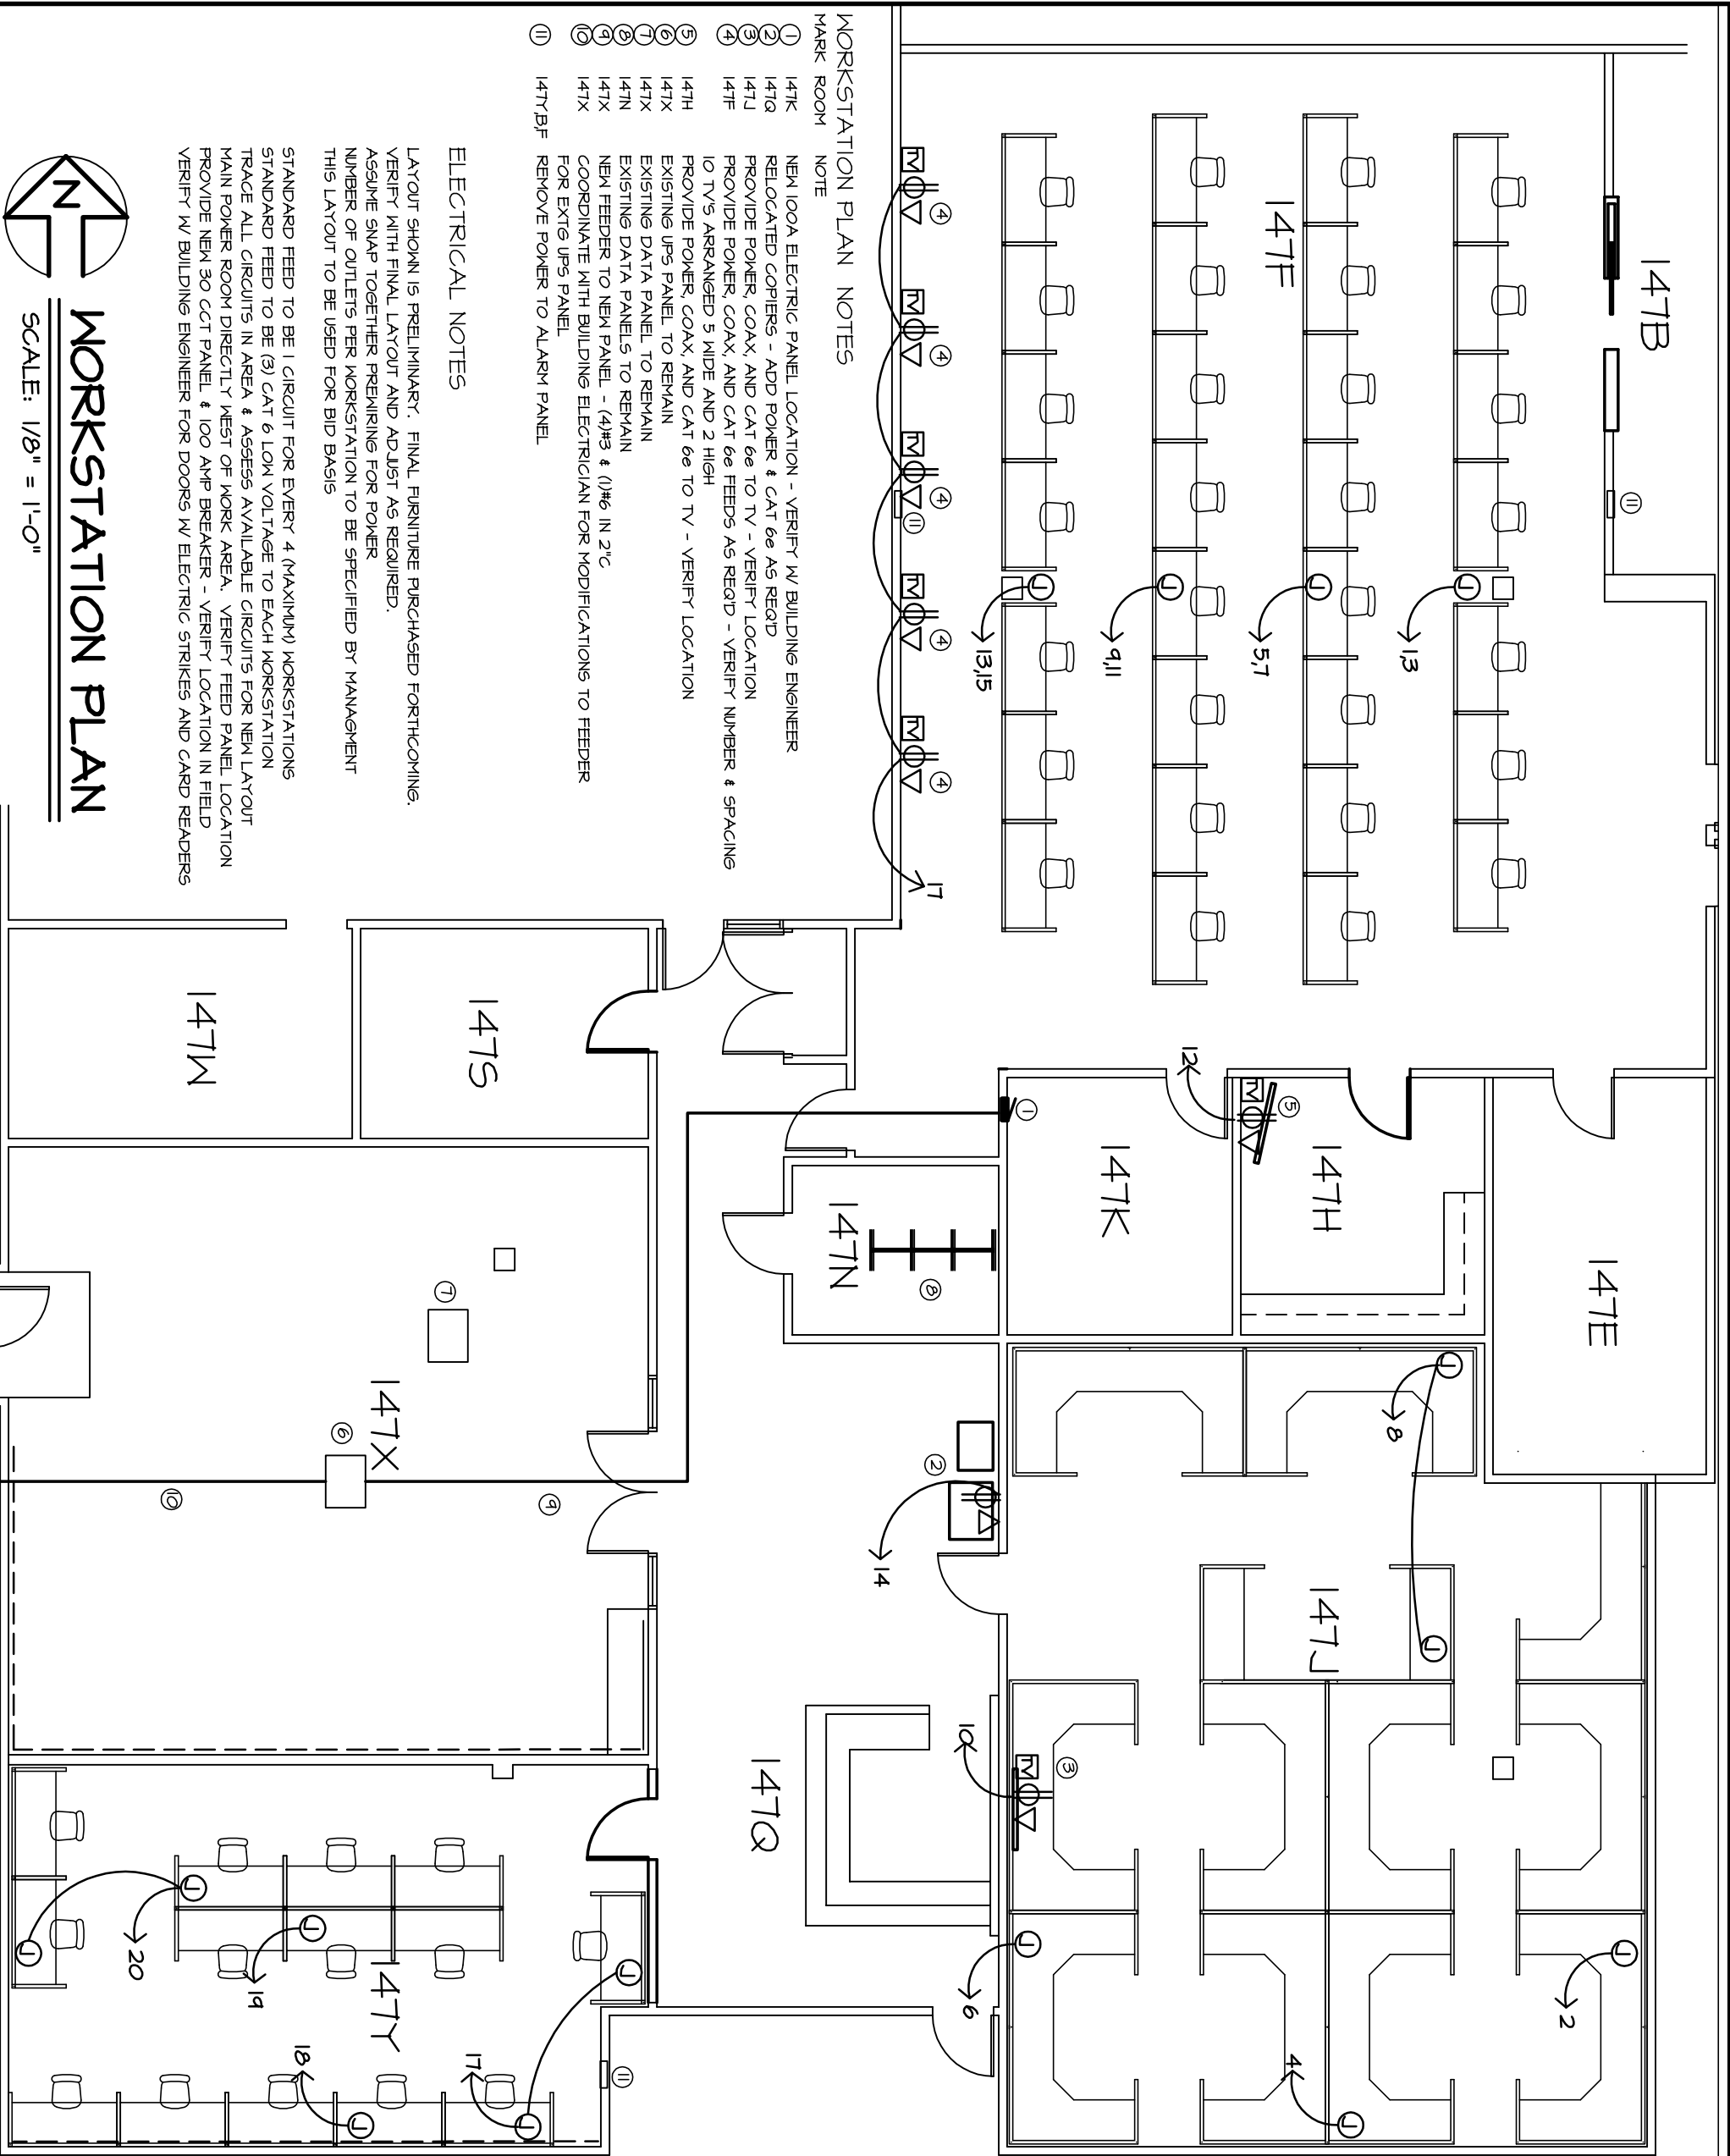
4	CLARIFICATIONS	3/24/13
3	CLARIFICATIONS	2/27/13
2	ADDED (2) CUBES, NOTE 3	1/24/13
1	FIRST CONCEPT	1/26/13
NO.	ISSUE	DATE

NSOC REMODELING
HINES VA

BUILDING
215

DRAWING TITLE
FLOOR PLAN

SCALE	NOTED	JOB NO.	13011
PLOT FILE		SHEET NUMBER	
DRAWN	LHIII	CHECKED	LHIII
OF	SHEETS		



WORKSTATION PLAN NOTES

- MARK ROOM NOTE
- 147K NEAR 100A ELECTRIC PANEL LOCATION - VERIFY W/ BUILDING ENGINEER
 - 147Q RELOCATED COPIERS - ADD POWER & CAT 6e AS REQ'D
 - 147J PROVIDE POWER, COAX, AND CAT 6e TO TV - VERIFY LOCATION
 - 147F PROVIDE POWER, COAX, AND CAT 6e FEEDS AS REQ'D - VERIFY NUMBER & SPACING 10 TVs ARRANGED 5 WIDE AND 2 HIGH
 - 147H PROVIDE POWER, COAX, AND CAT 6e TO TV - VERIFY LOCATION
 - 147X EXISTING UPS PANEL TO REMAIN
 - 147N EXISTING DATA PANELS TO REMAIN
 - 147X NEW FEEDER TO NEW PANEL - (4)#3 & (1)#6 IN 2"IC
 - 147X COORDINATE WITH BUILDING ELECTRICIAN FOR MODIFICATIONS TO FEEDER FOR EXISTG UPS PANEL
 - 147Y,B/F REMOVE POWER TO ALARM PANEL

ELECTRICAL NOTES

LAYOUT SHOWN IS PRELIMINARY. FINAL FURNITURE PURCHASED FORTHCOMING. VERIFY WITH FINAL LAYOUT AND ADJUST AS REQUIRED. ASSUME SNAP TOGETHER PREMIRING FOR POWER NUMBER OF OUTLETS PER WORKSTATION TO BE SPECIFIED BY MANAGEMENT THIS LAYOUT TO BE USED FOR BID BASIS

STANDARD FEED TO BE 1 CIRCUIT FOR EVERY 4 (MAXIMUM) WORKSTATIONS STANDARD FEED TO BE (3) CAT 6 LOW VOLTAGE TO EACH WORKSTATION TRACE ALL CIRCUITS IN AREA & ASSESS AVAILABLE CIRCUITS FOR NEW LAYOUT MAIN POWER ROOM DIRECTLY WEST OF WORK AREA. VERIFY FEED PANEL LOCATION PROVIDE NEW 30 Ckt PANEL & 100 AMP BREAKER - VERIFY LOCATION IN FIELD VERIFY W/ BUILDING ENGINEER FOR DOORS W/ ELECTRIC STRIKES AND CARD READERS

WORKSTATION PLAN

SCALE: 1/8" = 1'-0"